Pacific Community Communauté du Pacifique

PACIFIC COMMUNITY PROPOSED EXTENSION TO EXISTING BUILDING - CRYOGENIC LAB

FNTC ROAD 2, NARERE, NASINU.

DRAWING NUMBER	DRAWING TITLE	RI	EVISIO	ON	DRAWING NUMBER	DRA	WING TITLE	RE	EVISIO)N	DRAWING NUMBER	DRAWING TI	ITLE	REVISION	DRAWING NUMBER	DRA	WING TITLE	RE	EVISION
	ARCHITECTURAL DRAWINGS				A18	GROUND FLOOR F	EFLECTED CEILING PLAN	*				STRUCTURAL DRAW	/INGS			ELECTRICAL D	RAWINGS		
X001	SPECIFICATION	*			A19	DOOR SCHEDULE		*			S0	STRUCTURAL NOTES		*	E1	DRAWING INDEX		*	
X002	SPECIFICATION	*			A20	DOOR SCHEDULE	& DETAILS	*			S1	FOUNDATION PLAN		*	E2	GENERAL NOTES	ND ABBREVIATIONS	*	
X003	TENDER FORM	*			A21	WINDOW SCHEDU	E & DETAILS	*			S2	COLUMN ELEVATION & PAI	D DETAILS	*	E3	LIGHT FITTING SCH	IEDULE		
A0	SITE & LOCALITY PLAN	*									S3	RETAINING WALL DETAIL		*	E4	EXISTING ELECTRI	CAL SCHEMATICS	*	
A1	EXISTING GROUND FLOOR PLAN SHOWING	*									S4	FOOTING DETAILS		*	E5	PROPOSED ELECT	RICAL SCHEMATIC &	*	
AI	DEMOLITION	Ĺ									S5	FOOTING DETAILS		*	ES	CABLE SCHEDULE		^	
A2	PROPOSED GROUND FLOOR PLAN	*									S6	TYP. LINTEL BEAM & STRU	ICTURAL DETAILS	*	E6	PROPOSED COMM	UNICATIONS SCHEMATIC	*	
A3	ENLARGE GROUND FLOOR PLAN	*									S7	FIRST FLOOR BEAM FRAM	ING PLAN	*	⊏0	DIAGRAM		^	
A4	ENLARGE GROUND FLOOR DIMENSION PLAN	*									S8	BEAM ELEVATION & SECTI	ON	*	E400	EXISTING SITE LAY	OUT - ELECTRICAL	*	
A5	EXISTING FIRST FLOOR PLAN SHOWING	*									S9	STEEL ARRANGEMENT & S	SPLICE DETAILS	*	E100	SERVICES		^	
Ab	DEMOLITION	*									S10	FIRST FLOOR SLAB REINF.	. PLAN (bottom	*	E101		AYOUT - ELECTRICAL	*	
A6	PROPOSED FIRST FLOOR PLAN	*									310	steel)			EIOI	SERVICES		^	
A6a	ENLARGE FIRST FLOOR PLAN	*									S11	FIRST FLOOR SLAB REINF.	. PLAN (top steel)	*	E102	ELECTRICAL LAYO	UT - GROUND FLOOR	*	
A7	ELEVATIONS	*									S12	SLAB SECTION		*	E200	ELECTRICAL SECT	ONS LAYOUT	*	
A8	SECTION	*									S13	STEEL STAIR DETAILS		*					
A8a	SECTION	*									S14	STEEL STAIR DETAILS		*					
A9	SECTION	*																	
A10	SECTION	*																	
A11	STEEL STAIR PLAN	*																	
A12	STEEL STAIR SECTIONS	*																	
A13	STEEL STAIR DETAILS	*																	
A14	STEP 1 & 2 PLANS & RAILING DETAILS	*																	
A15	WALL ELEVATIONS	*																	
A16	WALL ELEVATIONS	*																	
A17	WALL SECTIONS																		
ISSUED 1	TO: DATE OF ISSUE	21.06.23			ISSUED 1	го:	DATE OF ISSUE	21.06.23			ISSUED T	го:	DATE OF ISSUE	21.06.23	ISSUED T	⁻ O:	DATE OF ISSUE	21.06.23	
NFA \ OH	ıs				NFA \ OH	IS					NFA \ OH	S		-,	NFA \ OH	s			
COUNCIL	_				COUNCIL	-					COUNCIL				COUNCIL				
STRUCTI	URAL ENGINEER				STRUCTI	URAL ENGINEER					STRUCTU	JRAL ENGINEER			STRUCTU	JRAL ENGINEER			
SERVICE	S ENGINEER				SERVICE	S ENGINEER					SERVICE	S ENGINEER			SERVICE	S ENGINEER			
CLIENT					CLIENT						CLIENT				CLIENT				
TENDER		E			TENDER			Е			TENDER			E	TENDER			E	
CONSTR	UCTION				CONSTR	UCTION					CONSTR	UCTION			CONSTR	UCTION			

E=Email, D=Disk, P=Paper

E=Email, D=Disk, P=Paper

E=Email, D=Disk, P=Paper

E=Email, D=Disk, P=Paper



SERVICES ENGINEER

ARCHITECTS DESIGN CONSULTANTS PROJECT MANAGERS

> 26 MARA ROAD , P.O.BOX 16 , NAUSORI , FIJI ISLANDS Phone: 3400 287 Fax: 3400 185 Mobile: 9990 626
> Email: designhut@connect.com.fi



Building Services Engineers | 17 Bhimji St. Wailoku GPO Box 11622, Suva, Fiji Islands p: +679 330 7060 |m: +679 999 0656 e: info@edisonconsultants.com

TENDER ISSUE 22.06.23

PROJECT NO. : 22-014 : 20.04.23 DATE DRAWN



Pacific Community Communauté du Pacifique

PACIFIC COMMUNITY PROPOSED EXTENSION TO EXISTING BUILDING - CRYOGENIC LAB

FNTC ROAD 2, NARERE, NASINU.

DRAWING NUMBER	DRAWING TITLE	REV	/ISION	DRAWING NUMBER	DRAWING TITLE	R	EVISION	DRAWING NUMBER	DRAWING TITLE	RE	EVISION	DRAWING NUMBER	DRA	WING TITLE	RE	VISION
	HYDRAULICS DRAWINGS				FIRE DRAWINGS				MECHANICAL DRAWINGS							
H1	DRAWING INDEX	*		F1	DRAWING INDEX	*		M1	DRAWING INDEX	*						
H2	GENERAL NOTES ABBREVIATIONS & LINETYPES	*		F2	GENERAL NOTES, ABBREVIATIONS AND LINE TYPES	*		M2	GENERAL NOTES, LEGEND OF SYMBOLS & ABBREVIATIONS	*						
НЗ	LEGEND OF SYMBOLS AND PIPE SCHEDULES	*		F3	PROPOSED EQUIPMENT SCHEDULE	*		М3	PROPOSED EQUIPMENT SCHEDULES	*						
H100	EXISTING SITE LAYOUT - HYDRAULICS	*		F100	EXISTING SITE LAYOUT - FIRE PROTECTION	*		M4	PROPOSED EQUIPMENT SCHEDULES	*						
H100	SERVICES			F101	PROPOSED SITE LAYOUT - FIRE PROTECTION	*		M10	EXISTING SITE LAYOUT	*						
H101	PROPOSED SITE LAYOUT - HYDRAULICS	*		F102	PROPOSED FIRE PROTECTION LAYOUT	*		M100	PROPOSED SITE LAYOUT	*						
11101	SERVICES			F200	PROPOSED FIRE PROTECTION DETAILS	*		M101	ENLARGED LAB LAYOUT - GROUND FLOOR	*						
H102	DOMESTIC COLD WATER LAYOUT - GROUND	 						M102	ENLARGED LAB LAYOUT - FIRST FLOOR	*						
11102	FLOOR							M200	PROPOSED MECHANICAL ELEVATIONS	*						
H200	DOMESTIC SANITARY WASTE LAYOUT -	*						M201	PROPOSED MECHANICAL SECTION X	*						
11200	GROUND FLOOR							M202	PROPOSED MECHANICAL SECTION Y	*						
H300	DOMESTIC COLD WATER SCHEMATICS	*						M300	PROPOSED MECHANICAL DETAILS	*						
11300	LAYOUT															
H301	DOMESTIC SANITARY WASTE SCHEMATICS	*							SPECIFICATION							
11001	LAYOUT							1 BOOKLET	DESIGN HUT SPECIFICATION BOOK	*						
H400	HYDRAULICS SECTIONS X AND Y	*														
H401	HYDRAULICS SECTION Z	*														
H500	HYDRAULICS DETAILS	*														
H501	HYDRAULICS DETAILS	*														
ISSUED T	TO: DATE OF ISSUE	21.06.23		ISSUED T	TO: DATE OF ISSUE	21.06.23		ISSUED 1	TO: DATE OF ISSUE	21.06.23		ISSUED T	O:	DATE OF ISSUE		
NFA \ OH	IS			NFA \ OH	s			NFA \ OH	ıs			NFA \ OHS	s			
COUNCIL	-			COUNCIL				COUNCIL	-			COUNCIL				
STRUCTU	URAL ENGINEER			STRUCTU	JRAL ENGINEER			STRUCT	URAL ENGINEER			STRUCTU	IRAL ENGINEER			
SERVICE	S ENGINEER			SERVICE	S ENGINEER			SERVICE	S ENGINEER			SERVICES	S ENGINEER			
CLIENT				CLIENT				CLIENT				CLIENT				
TENDER		E		TENDER		Е		TENDER		Е		TENDER				
CONSTRI	UCTION			CONSTRI	UCTION			CONSTR	UCTION			CONSTRU	JCTION			

design =

E=Email, D=Disk, P=Paper

E=Email, D=Disk, P=Paper

E=Email, D=Disk, P=Paper

SERVICES ENGINEER



26 MARA ROAD , P.O.BOX 16 , NAUSORI , FIJI ISLANDS Phone : 3400 287 Fax : 3400 185 Mobile : 9990 626 Email : designhut@connect.com.fj



Building Services Engineers | 17 Bhimji St. Wailoku GPO Box 11622, Suva, Fiji Islands p: +679 330 7060 |m: +679 999 0656 e: info@edisonconsultants.com

TENDER ISSUE 22.06.23


PROJECT NO. : 22-014

DATE : 20.04.23

DRAWN : S.S.K

PAGE : 2



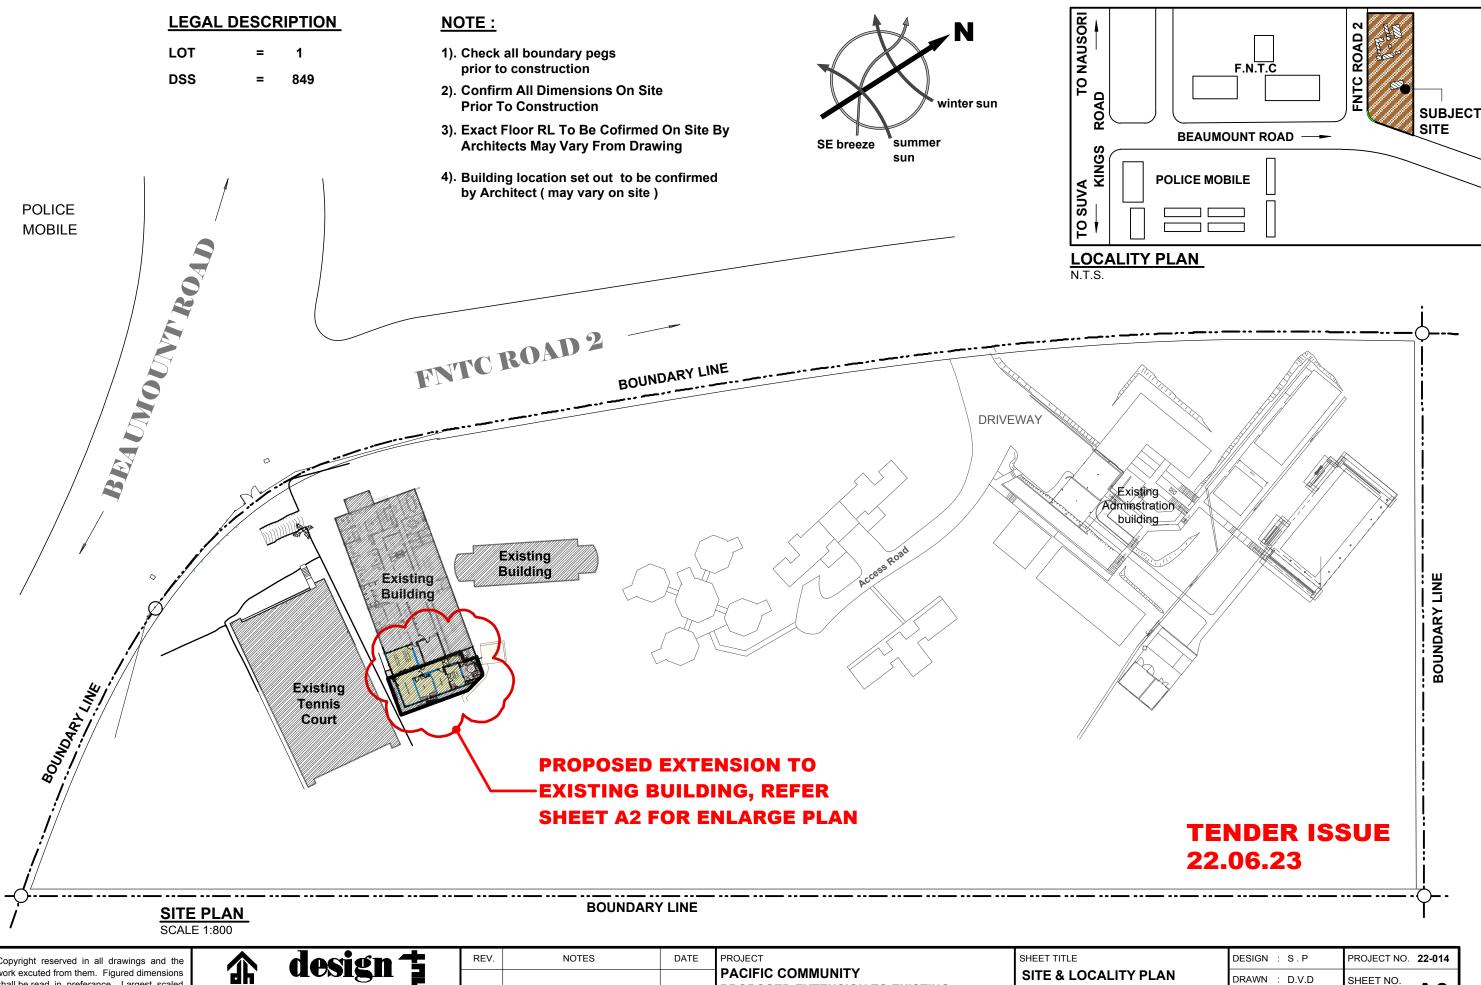


Copyright reserved in all drawings and the work excuted from them. Figured dimensions shall be read in preferance. Largest scaled drawings shall take precedence. Check all dimensions on site. All discrepancies shall be reported to the **ARCHITECT** immediately.

	design ‡	
	NSULTANTS,PROJECT MANAGERS,INTERIOR D	
26 MARA ROA	ND , P.O.BOX 16 , NAUSORI , FIJI ISLANI	os
PI	H 3400 287 , FAX 3400 185	

Email: designhut@connect.com.fj

REV.	NOTES	DATE	PROJECT
			PACIFIC COMMUNITY PROPOSED EXTENSION TO EXISTING
			BUILDING - CRYOGENIC LAB
			FNTC ROAD 2, NARERE, NASINU.

T TITLE	DESIGN	:	S.P	PROJE	CT N	10.	22-0	14
E & LOCALITY PLAN	DRAWN	:	D.V.D	SHEE	ΓNC).	A (<u> </u>
	DATE	:	23.08.22				A	U
	SCALE	:	AS SHOWN	REV.				

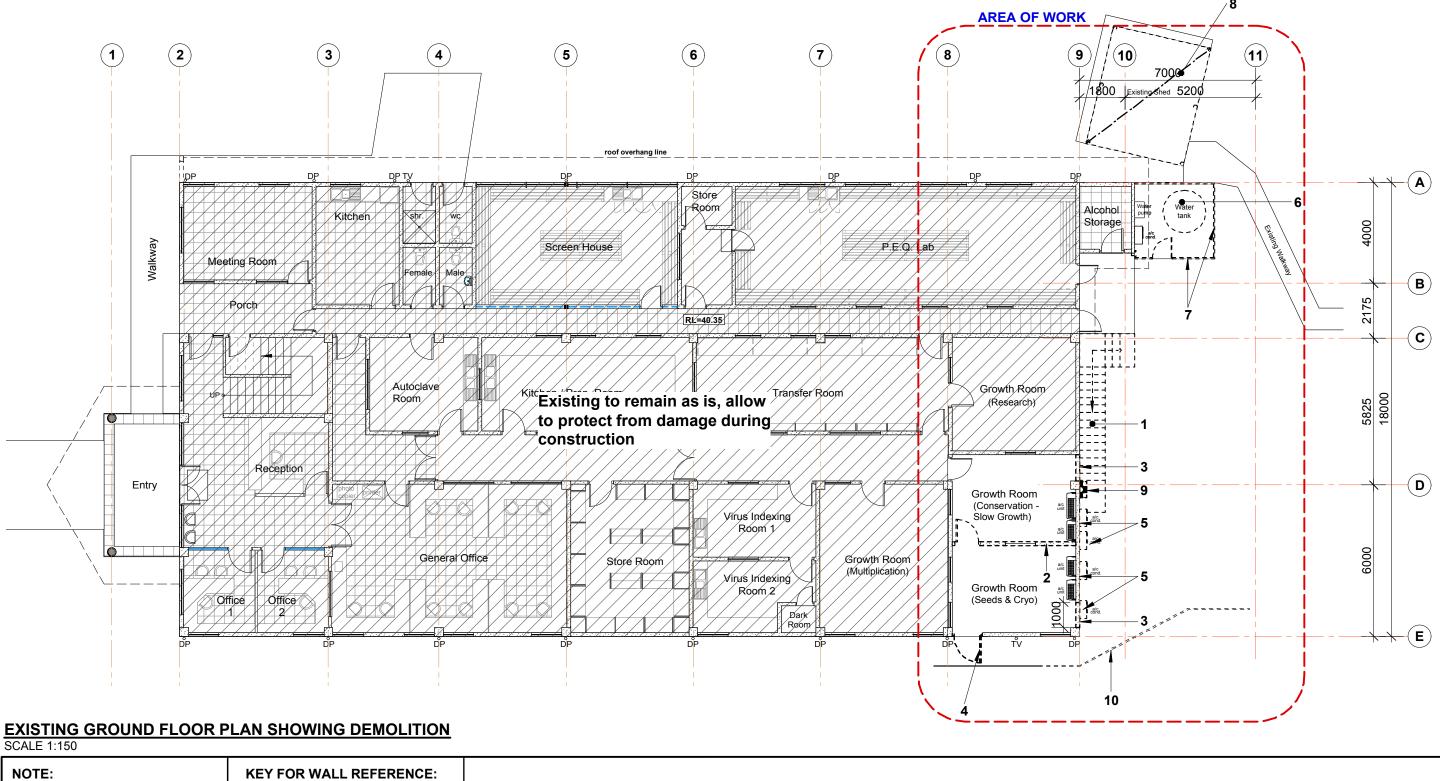

a. Confirm all dimensions on site prior to 5. Allow to relocate existing A/c condenssor units as 9. Allow to relocate existing main switch board as 1. Allow to demolish existing stair & make good construction per electrical drawing to all damages per mechanical drawings b. All demolished materials shall become the 2. Allow to demolish existing wall shown 6. Allow to relocate existing tank as per new layout, 10. Allow to demolish part of existing railing shown property of the owner unless stated. contractor to allow for new piping dotted & make good to all damages dotted & make good to all damages Materials not required by the owner shall 7. Allow to remove existing tank enclosure & make 3. Allow to demolish part of existing wall shown be removed from the site by the contractor dotted for new openings as per proposed plan good to all damages c. Allow to paint all new works area as per **TENDER ISSUE** Allow to demolish existing shed structure & make Architect Instructions 1. Allow to remove existing doors shown dotted good to all damages & install new wall & window & make good to 22.06.23 all damages

Copyright reserved in all drawings and the work excuted from them. Figured dimensions shall be read in preferance. Largest scaled drawings shall take precedence. Check all dimensions on site. All discrepancies shall be reported to the **ARCHITECT** immediately.

ARCHITECTS, DESIGN CONSULTANTS, PROJECT MANAGERS, INTERIOR DESIGNE
26 MARA ROAD , P.O.BOX 16 , NAUSORI , FIJI ISLANDS
PH. - 3400 287 , FAX. - 3400 185

REV. NOTES DATE

PROJECT
PACIFIC COMMUNITY
PROPOSED EXTENSION TO EXISTING
BUILDING - CRYOGENIC LAB
FNTC ROAD 2, NARERE,
NASINU.


EXISTING GROUND FLOOR
PLAN SHOWING DEMOLITION

 DESIGN : S.P
 PROJECT NO.
 22-014

 DRAWN : A.D.S
 SHEET NO.

 DATE : 24.08.22
 A1

 SCALE : AS SHOWN
 REV.

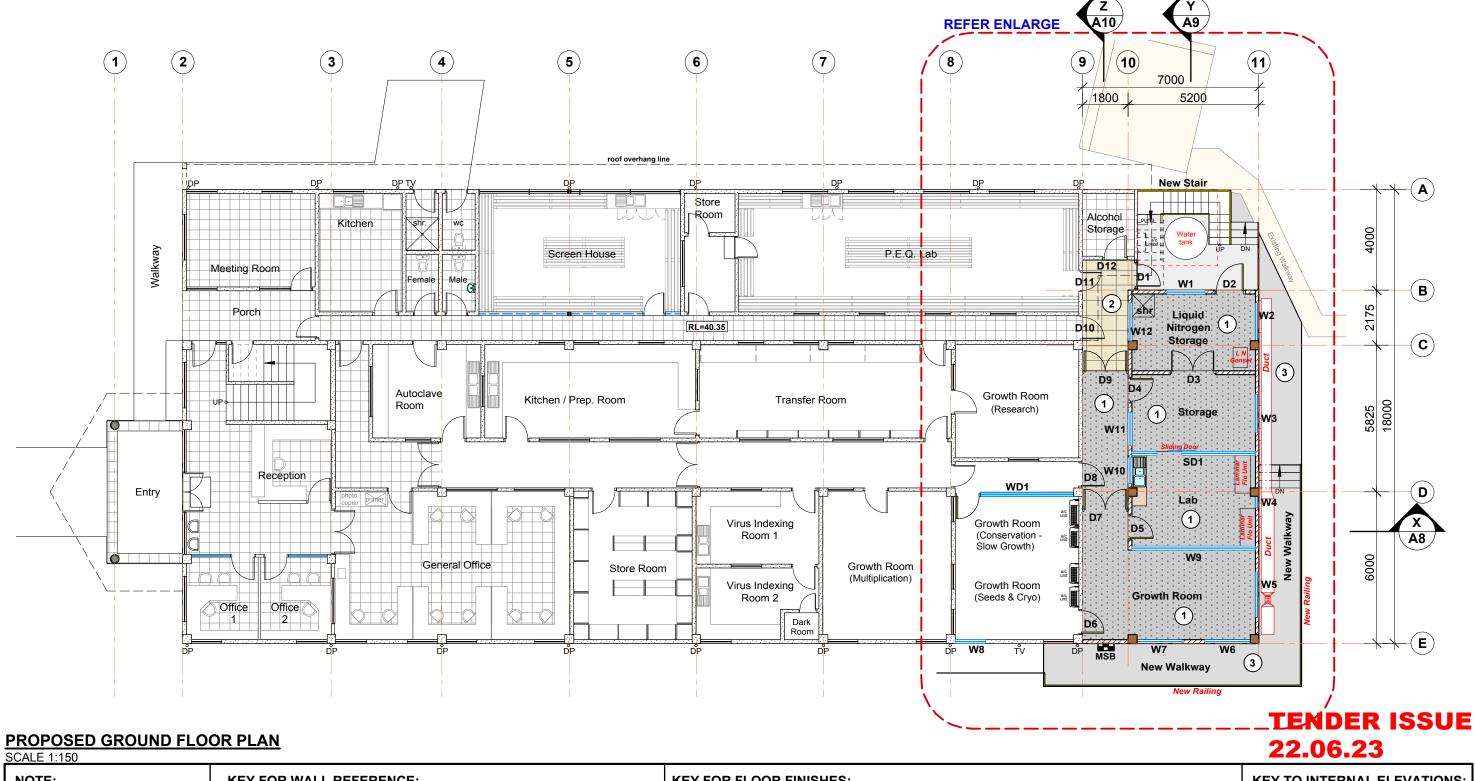

NOTE:	KEY FOR WALL REFERENCE:	KEY FOR FLOOR FINISHES:	KEY TO INTERNAL ELEVATIONS:
 confirm all dimensions on site prior to construction Whole of exterior & interior to be painted as per Architects instruction All floor tiles to be laid as per 	Existing conc. blockwall to be painted as per Architects instruction Existing timber wall, allow to change all wall linings as per Architects instruction New 150mm conc. blockwall plastered & painted	3.5mm vinyl sheet flooring with 150mm coveing, installed as per Manufacturer's instruction (Tarkett Range) Approx. Area - 90 sqm Supplier - Eden Associate - Suva Selected Ceramic floor tiles to be supplied by client, Contractor to install including adhesive. (Ardex - X18) & grout.	KEY TO EXTERIOR ELEVATIONS:
Architects instruction	as per Architects instruction	install including adhesive. (Ardex - X18) & grout. Approx. Area - 8 sqm Total Enclosed Area - 98 sq.m.	A


Copyright reserved in all drawings and the work excuted from them. Figured dimensions shall be read in preferance. Largest scaled drawings shall take precedence. Check all dimensions on site. All discrepancies shall be reported to the ARCHITECT immediately.


↑ design ±	REV.	NOTES	DATE
ar acsien a			
ARCHITECTS, DESIGN CONSULTANTS, PROJECT MANAGERS, INTERIOR DESIGNERS 26 MARA ROAD, P.O.BOX 16, NAUSORI, FIJI ISLANDS			
PH 3400 287 , FAX 3400 185 Email : designhut@connect.com.fj			

PACIFIC COMMUNITY PROPOSED EXTENSION TO EXISTING BUILDING - CRYOGENIC LAB FNTC ROAD 2, NARERE, NASINU.

PROPOSED GROUND FLOOR PLAN

DESIGN : S.P PROJECT NO. **22-014** DRAWN R.M/A.D.S SHEET NO. **A2** : 20.01.23 : AS SHOWN REV.

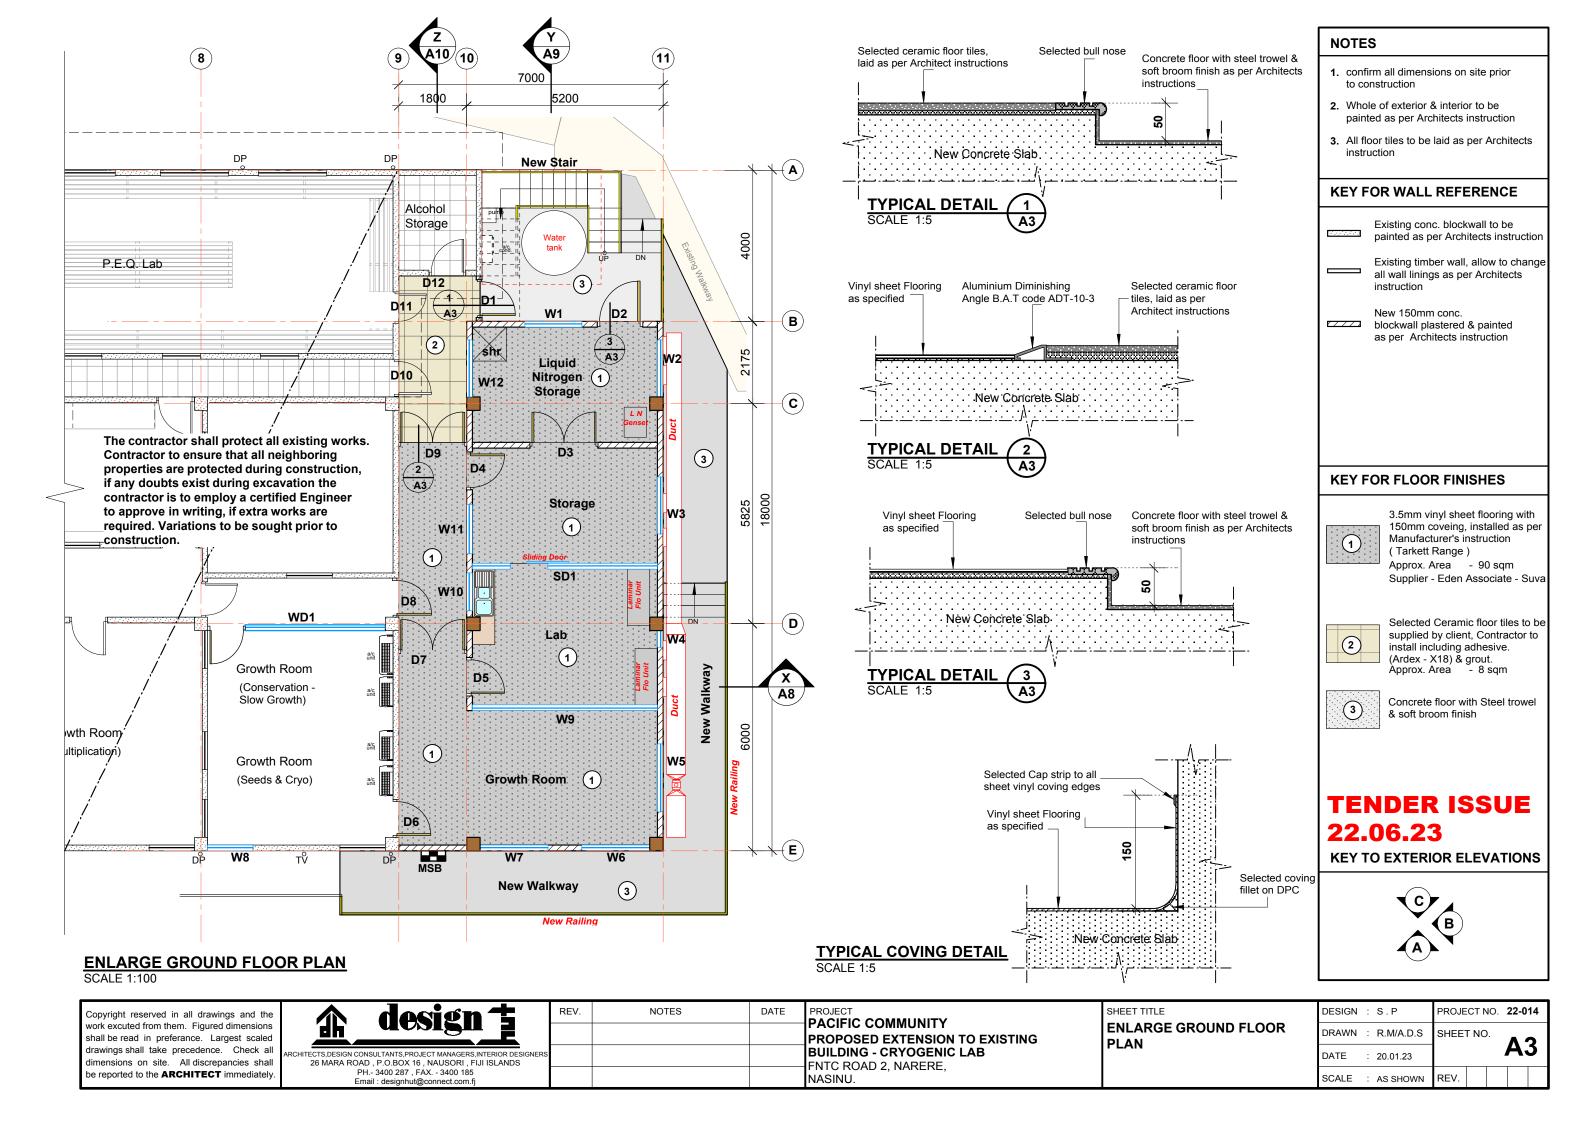

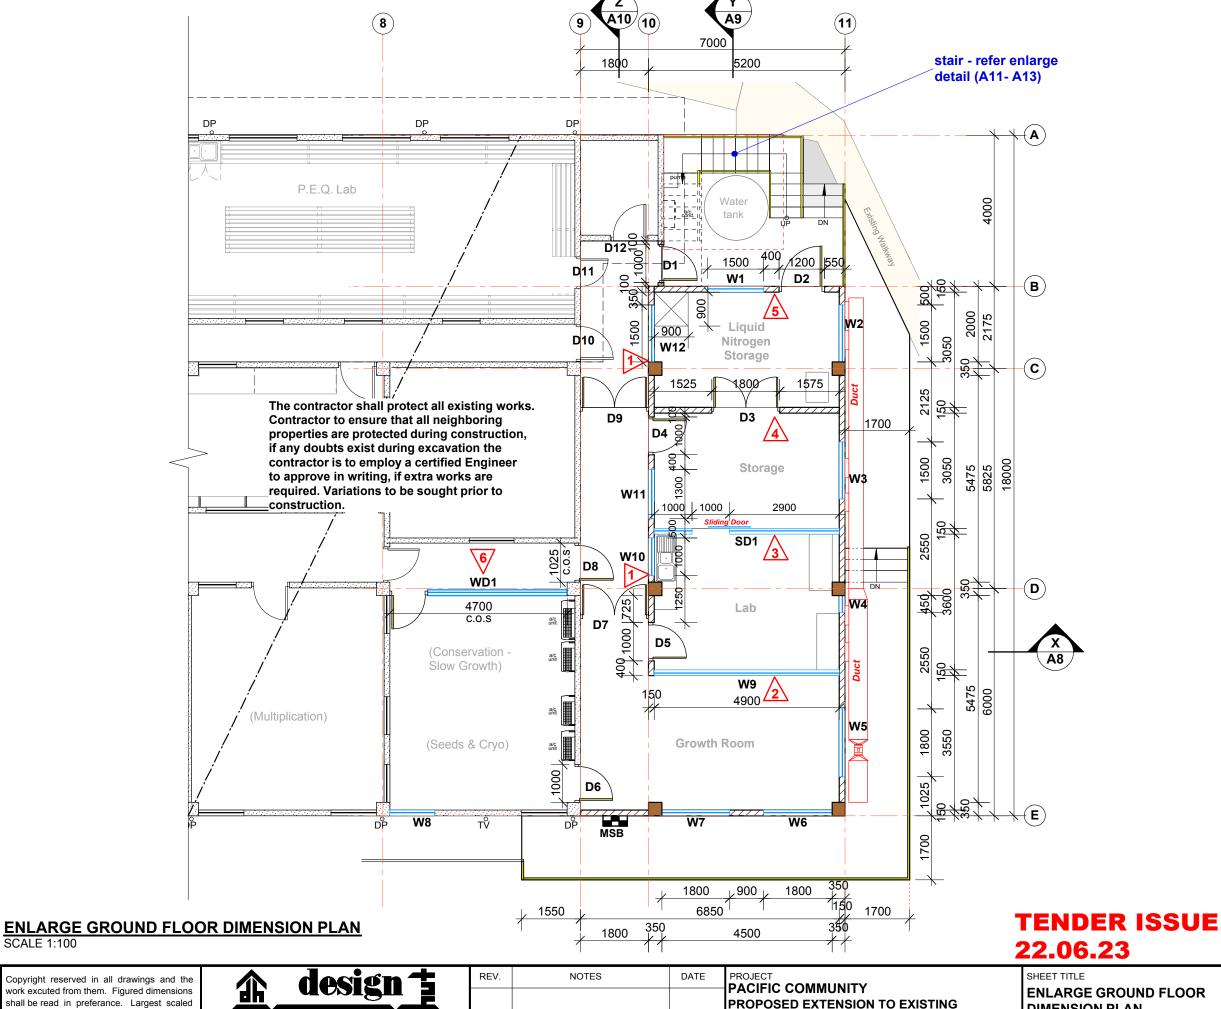

NOTES

- 1. confirm all dimensions on site prior to construction
- 2. Whole of exterior & interior to be painted as per Architects instruction
- 3. All floor tiles to be laid as per Architects instruction

KEY FOR WALL REFERENCE

Existing conc. blockwall to be painted as per Architects instruction

Existing timber wall, allow to change all wall linings as per Architects instruction

New 150mm conc. blockwall plastered & painted as per Architects instruction

KEY TO INTERNAL ELEVATIONS



KEY TO EXTERIOR ELEVATIONS




work excuted from them. Figured dimensions shall be read in preferance. Largest scaled drawings shall take precedence. Check all dimensions on site. All discrepancies shall be reported to the ARCHITECT immediately

TECTS DESIGN CONSULTANTS PROJECT MANAGERS INTERIOR DESIGNE 26 MARA ROAD , P.O.BOX 16 , NAUSORI , FIJI ISLANDS PH.- 3400 287 , FAX. - 3400 185

PROPOSED EXTENSION TO EXISTING BUILDING - CRYOGENIC LAB FNTC ROAD 2, NARERE, NASINU.

ENLARGE GROUND FLOOR DIMENSION PLAN

DESIGN : S.P PROJECT NO. **22-014** DRAWN R.M/A.D.S SHEET NO. **A4** : 20.01.23 SCALE : AS SHOWN REV.

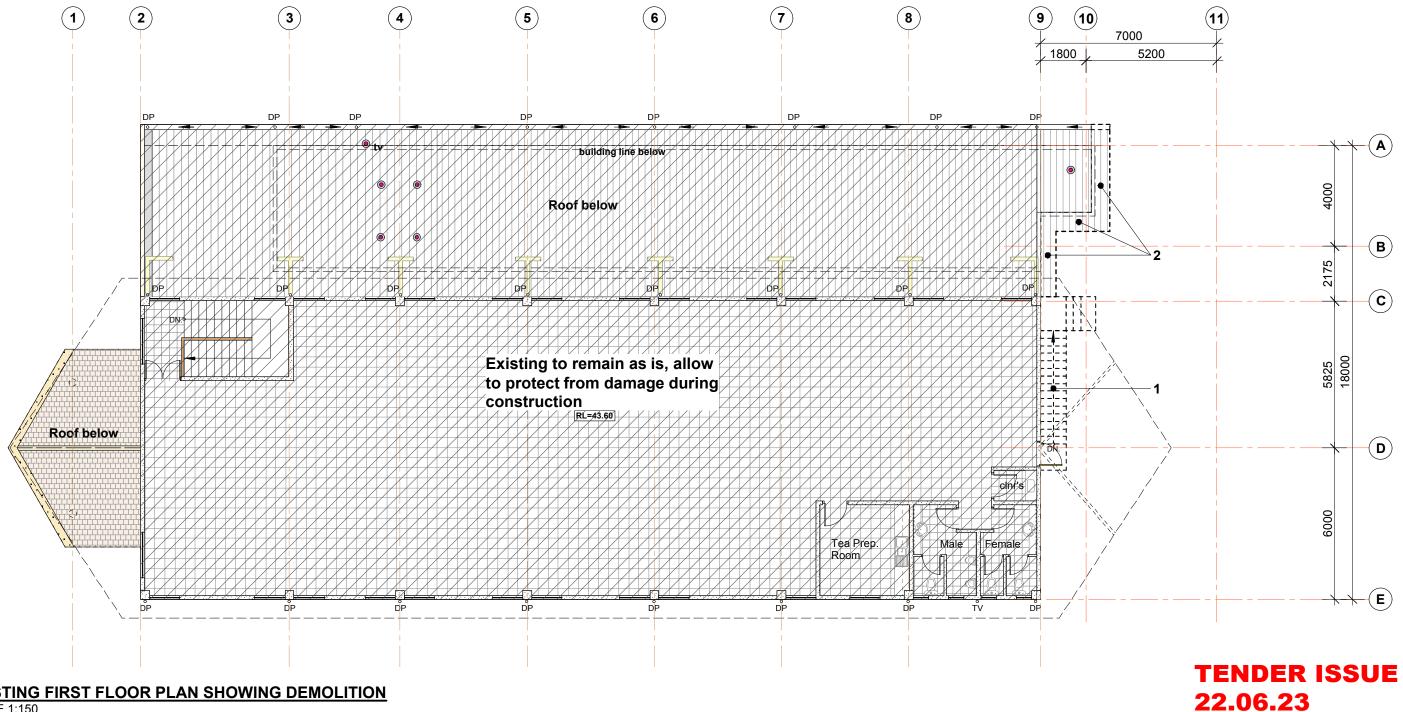

EXISTING FIRST FLOOR PLAN SHOWING DEMOLITION SCALE 1:150

_	JOALL 1.130		
	NOTE:	KEY FOR WALL REFERENCE:	
	 a. Confirm all dimensions on site prior to construction b. All demolished materials shall become the property of the owner unless stated. Materials not required by the owner shall be removed from the site by the contractor c. Allow to paint all new works area as per 	Allow to demolish existing stair & make good to all damages Allow to remove existing roof overhang shown dotted for new parapet wall over existing wall, make good to all damages	
	Architect Instructions		

Copyright reserved in all drawings and the work excuted from them. Figured dimensions shall be read in preferance. Largest scaled drawings shall take precedence. Check all dimensions on site. All discrepancies shall be reported to the **ARCHITECT** immediately.


<u> </u>	design ‡
26 MARA ROA	NSULTANTS,PROJECT MANAGERS,INTERIOR DESIGNE ND , P.O.BOX 16 , NAUSORI , FIJI ISLANDS H 3400 287 , FAX 3400 185

REV.

NOTES	 PROJECT PACIFIC COMMUNITY
	PROPOSED EXTENSION TO EXISTING
	BUILDING - CRYOGENIC LAB FNTC ROAD 2, NARERE,
	NASINU.

EXISTING FIRST FLOOR PLAN SHOWING DEMOLITION

DESIGN	:	S.P	PROJE	CT N	10.	22-0	14
DRAWN	:	A.D.S	SHEE	ΓNC).	A	_
DATE	:	24.08.22				A;	C
SCALE	:	AS SHOWN	REV.				

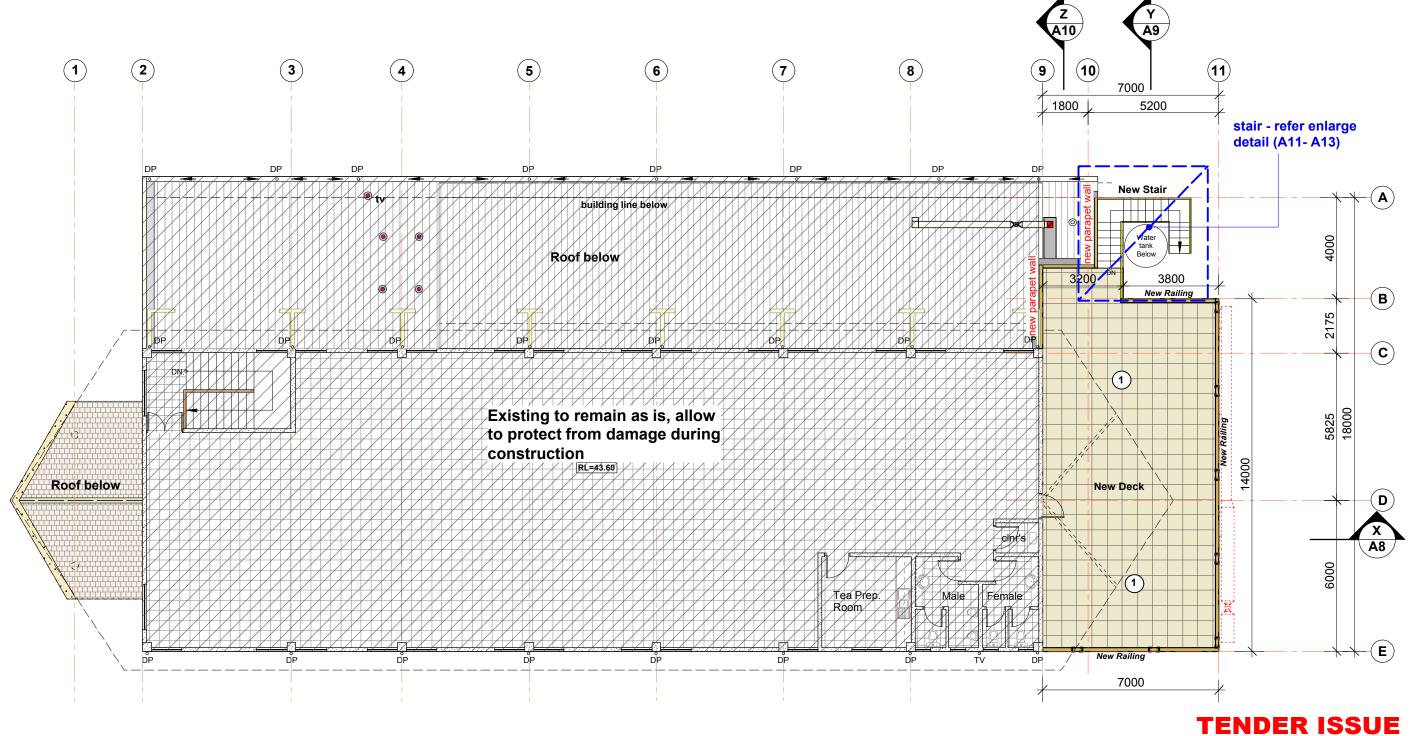

PROPOSED FIRST FLOOR PLAN SCALE 1:150

22.06.23

NOTE:	KEY FOR WALL REFERENCE:	KEY FOR FLOOR FINISHES:	KEY TO INTERNAL ELEVATIONS:
1. Confirm all dimensions on site prior to construction 2. Whole of exterior & interior to be painted as per Architects instruction 3. All floor tiles to be laid as per Architects instruction	Existing conc. blockwall to be painted as per Architects instruction Existing timber wall, allow to change all wall linings as per Architects instruction New 150mm conc. blockwall plastered & painted as per Architects instruction	Selected NON - SLIP Ceramic floor tiles to be supplied by client, Contractor to install including adhesive. (Ardex - X18) & grout. Approx. Area - 100 sqm	KEY TO EXTERIOR ELEVATIONS:

Copyright reserved in all drawings and the work excuted from them. Figured dimensions shall be read in preferance. Largest scaled drawings shall take precedence. Check all dimensions on site. All discrepancies shall be reported to the **ARCHITECT** immediately.


	design ‡
26 MARA ROA	NSULTANTS,PROJECT MANAGERS,INTERIOR DESIGN D , P.O.BOX 16 , NAUSORI , FIJI ISLANDS
	H 3400 287 , FAX 3400 185 nail : designhut@connect.com.fj

REV.

NOTES	DATE	PROJECT PACIFIC COMMUNITY
		PROPOSED EXTENSION TO EXISTING
		BUILDING - CRYOGENIC LAB FNTC ROAD 2, NARERE,
		NASINU.

SHEET TITLE	DESIGN	:	S.P
PROPOSED FIRST FLOOR PLAN	DRAWN	:	R.M/A.D.S
	DATE	:	24.01.23
	SCALE	:	AS SHOWN

DESIGN	:	S.P	PROJE	CT N	10.	22-0	14
DRAWN	:	R.M/A.D.S	SHEE	ΓNC).	A 4	
DATE	:	24.01.23			4	A(o
SCALE	:	AS SHOWN	REV.				

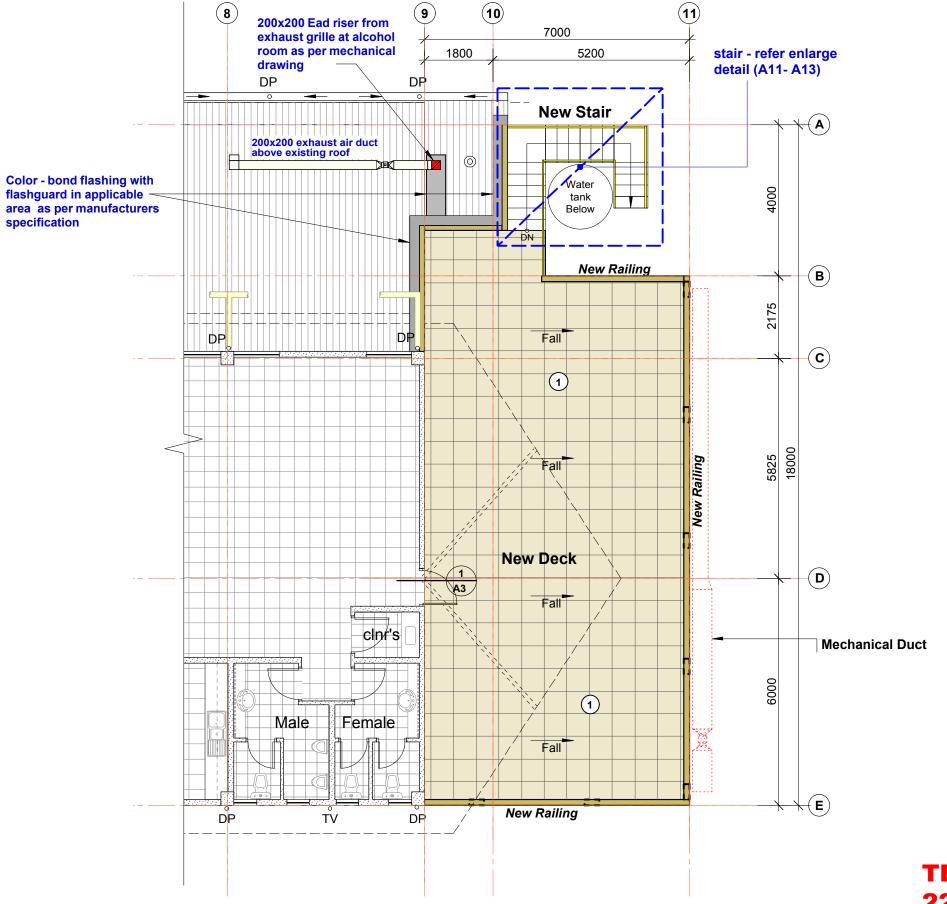

NOTES

- 1. Confirm all dimensions on site prior to construction
- 2. Whole of exterior & interior to be painted as per Architects instruction
- 3. All floor tiles to be laid as per Architects instruction

KEY FOR WALL REFERENCE

Existing conc. blockwall to be painted as per Architects instruction



Existing timber wall, allow to change all wall linings as per Architects instruction



New 150mm conc. blockwall plastered & painted as per Architects instruction

KEY FOR FLOOR FINISHES



Selected Non-Slip Ceramic floor tiles to be supplied by client, Contractor to install including adhesive.

(Ardex - X18) & grout. Approx. Area - 100 sqm

KEY TO INTERNAL ELEVATIONS

KEY TO EXTERIOR ELEVATIONS



TENDER ISSUE 22.06.23

Copyright reserved in all drawings and the work excuted from them. Figured dimensions shall be read in preferance. Largest scaled drawings shall take precedence. Check all dimensions on site. All discrepancies shall be reported to the ARCHITECT immediately

TECTS.DESIGN CONSULTANTS.PROJECT MANAGERS.INTERIOR DESIGNE 26 MARA ROAD , P.O.BOX 16 , NAUSORI , FIJI ISLANDS PH.- 3400 287 , FAX. - 3400 185

REV. NOTES PROJECT DATE PACIFIC COMMUNITY PROPOSED EXTENSION TO EXISTING BUILDING - CRYOGENIC LAB FNTC ROAD 2, NARERE, NASINU.


SHEET TITLE **ENLARGE FIRST FLOOR** PLAN

DESIGN : S.P PROJECT NO. **22-014** DRAWN R.M/N.S.S SHEET NO.

DATE 24.01.23 SCALE AS SHOWN

REV.

A6a

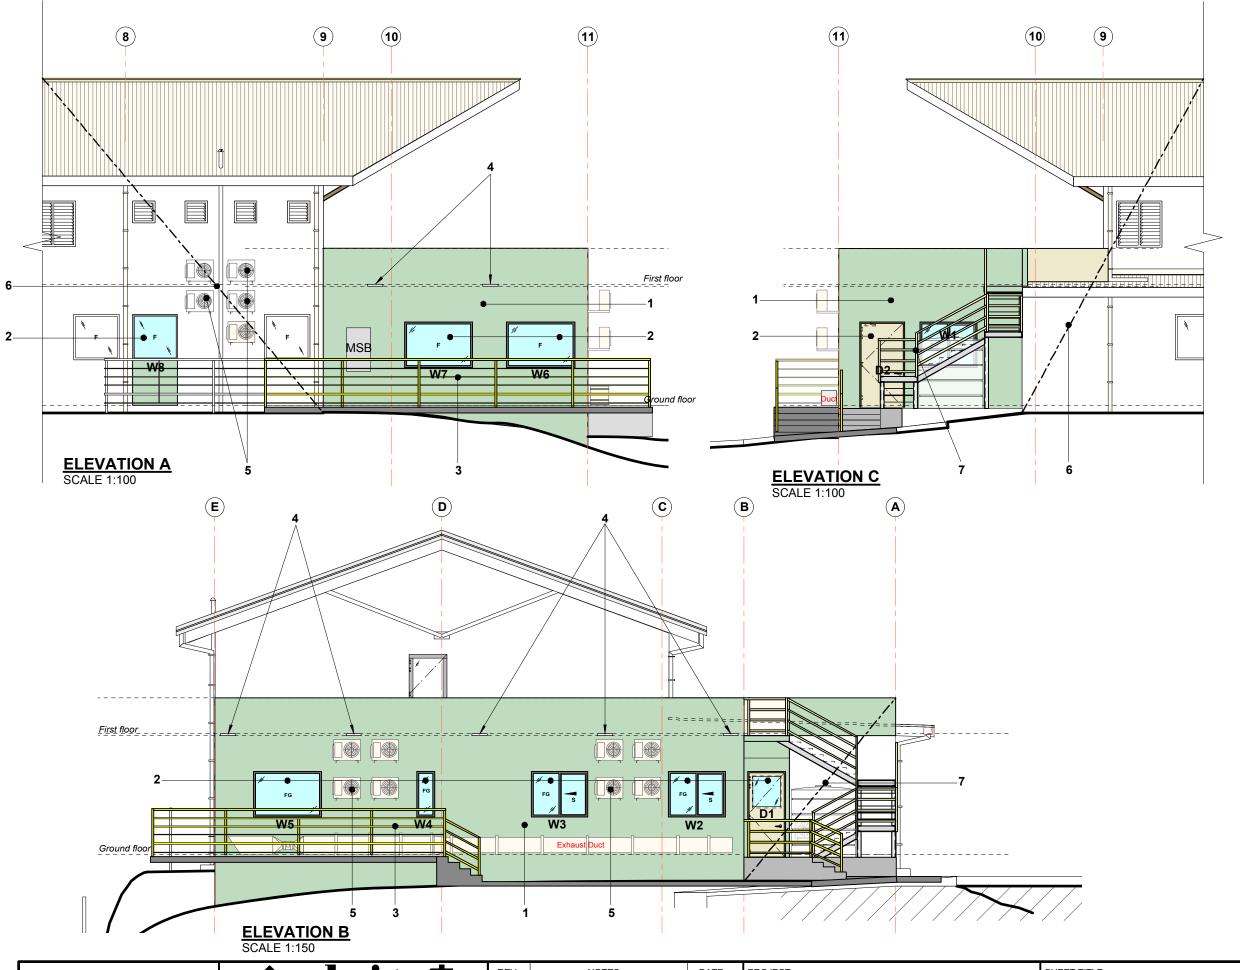

NOTE:

- Confirm all dimensions on site prior to construction
- 2. Whole of exterior & interior to be painted as per Architects instruction
- All floor tiles to be laid as per Architects instruction

KEY NUMBER REFERENCE:

- Concrete blockwall plastered & painted as per Architects instruction
- 2. New door/window as per schedule
- 3. Railing as per detail
- 4. 400 x 50mm weep holes in concrete railing
- Existing & new A/c condensor units refer mechanical drawings (exact locations to be confirmed on site)
- 6. The contractor shall protect all existing works Contractor to ensure that all neighboring properties are protected during construction, if any doubts exist during excavation the contractor is to employ a certified Engineer to approve in writing, if extra works are required. Variations to be sought prior to construction.
- 7. New steel stair as per details

TENDER ISSUE 22.06.23

Copyright reserved in all drawings and the work excuted from them. Figured dimensions shall be read in preferance. Largest scaled drawings shall take precedence. Check all dimensions on site. All discrepancies shall be reported to the **ARCHITECT** immediately.

HITECTS,DESIGN CONSULTANTS,PROJECT MANAGERS,INTERIOR DESIGNED 26 MARA ROAD , P.O.BOX 16 , NAUSORI , FIJI ISLANDS PH. 3400 287 , FAX. - 3400 185

REV. NOTES DATE PROJECT PACIFIC PROPOS BUILDIN FNTC RC NASINU.

PROJECT
PACIFIC COMMUNITY
PROPOSED EXTENSION TO EXISTING
BUILDING - CRYOGENIC LAB
FNTC ROAD 2, NARERE,
NASINII


PROPOSED ELEVATIONS

 DESIGN : S.P
 PROJECT NO.
 22-014

 DRAWN : R.M/A.D.S
 SHEET NO.

 DATE : 20.01.23
 A7

 SCALE : AS SHOWN
 REV.

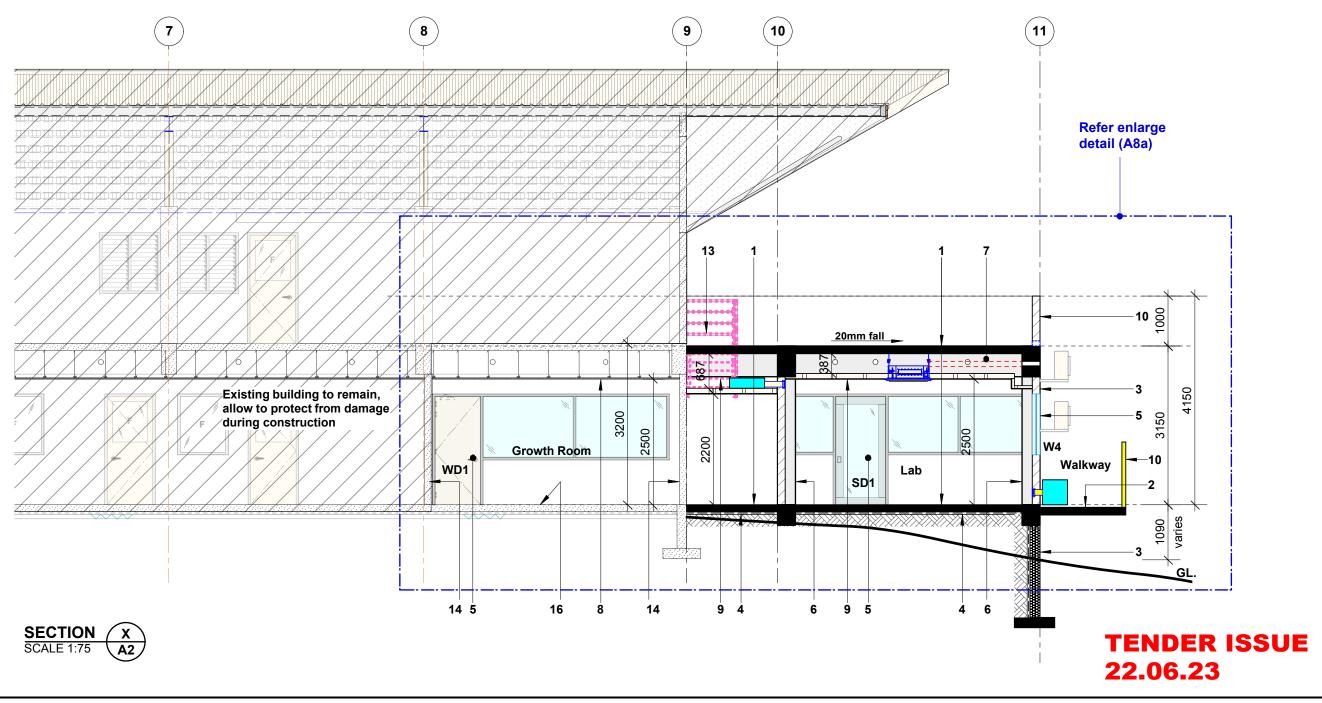

- 1 Concrete floor with selected tile finish refer floor plans
- 2 Steel trowel finish with soft broom finish as approved by the Architect.
- 3 Concrete blockwall plastered & painted from bothsides as per Architects instruction
- 4 Polythene dpc on 50 mm sand blinding and 100 well compacted hardcore fill
- 5 Door / window as per detail

- 6 Concrete column refer structural drawing for details. Column to be plastered & painted as per Architects instruction
- 7 Concrete beam, refer structural drawing for size & fixing
- 8 Existing ceiling to Remain, Allow to Make Good to all damages & Paint As Per Architects
- 9 13mm gib board ceiling on timber framing with P50 shadowline stopping angle to be painted as per Architects instructions

- 10 Railing as per detail
- Allow to remove all A/C outdoor units and installed to new location as per services drawings. Contractor to allow to make good to all damages.
- 12 Allow to remove existing Main Switch Board and relocate to new location as marked in electrical drawings. Contractor to allow to make good to all damages.
- Allow to demolish existing concrete steps & railing shown dotted & make good to all damages.
- Existing concrete wall / timber to remain, allow to make good to all damages & to be painted as per Architects instruction
- 15 Existing concrete column & beam to remain, allow to make good to all damages & to be painted as per Architects instruction
- 16 Existing floor tiles to remain as it is, allow to protect from damage during construction
- 17 Stair as per details

Copyright reserved in all drawings and the work excuted from them. Figured dimensions shall be read in preferance. Largest scaled drawings shall take precedence. Check all dimensions on site. All discrepancies shall be reported to the **ARCHITECT** immediately

design 1

RCHITECTS, DESIGN CONSULTANTS, PROJECT MANAGERS, INTERIOR DESIGNE

26 MARA ROAD . P.O.BOX 16 . NAUSORI . FIJI ISI ANDS

PH.- 3400 287 , FAX. - 3400 185

REV. NOTES DATE PROPARED PROPA

PROJECT
PACIFIC COMMUNITY
PROPOSED EXTENSION TO EXISTING
BUILDING - CRYOGENIC LAB
FNTC ROAD 2, NARERE,
NASINU.


SHEET TITLE SECTION

 DESIGN : S.P
 PROJECT NO. 22-014

 DRAWN : R.M/D.V.D
 SHEET NO.

 DATE : 25.01.23
 A8

 SCALE : 1:75
 REV.

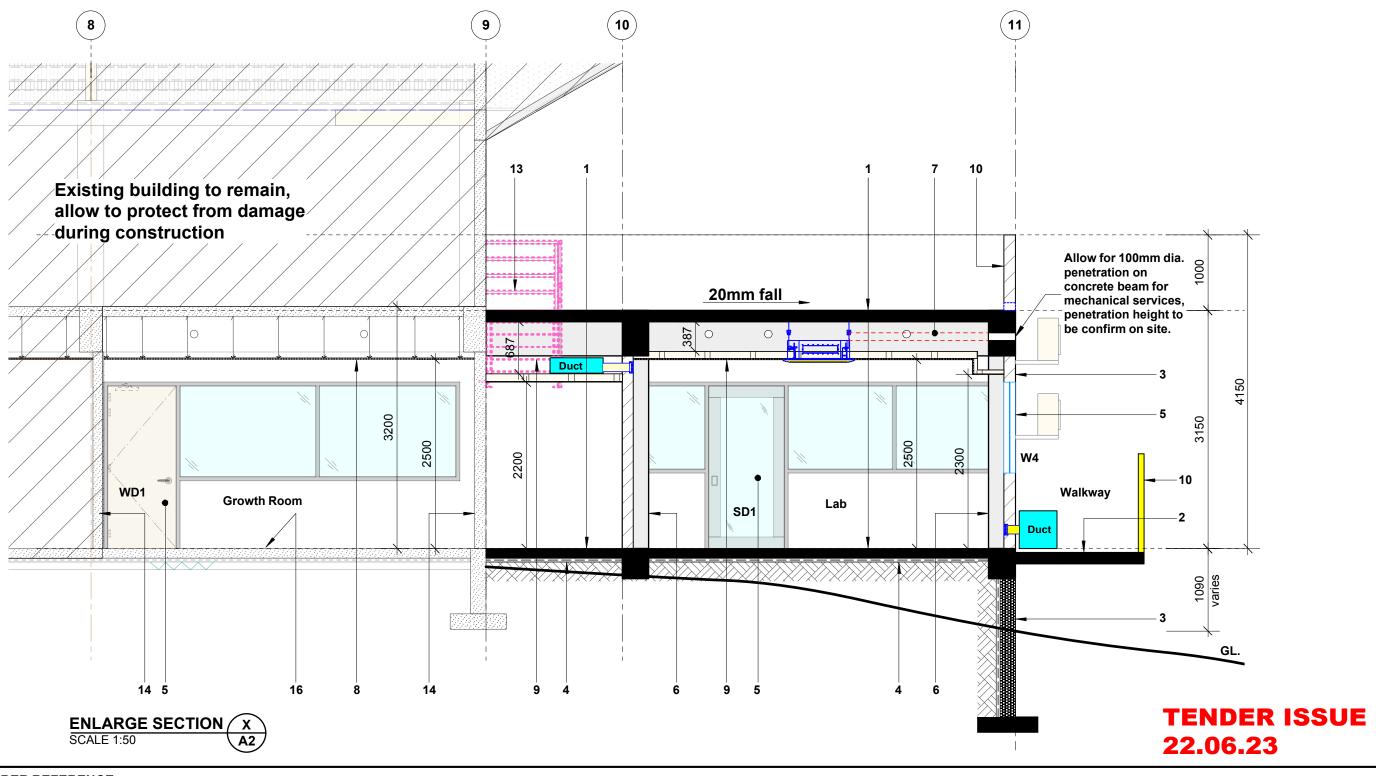

- 1 Concrete floor with selected tile finish refer
- 2 Steel trowel finish with soft broom finish as approved by the Architect.
- 3 Concrete blockwall plastered & painted from bothsides as per Architects instruction
- 4 Polythene dpc on 50 mm sand blinding and 100 well compacted hardcore fill
- 5 Door / window as per detail

- 6 Concrete column refer structural drawing for details. Column to be plastered & painted as per Architects instruction
- 7 Concrete beam, refer structural drawing for size & fixing
- 8 Existing ceiling to Remain, Allow to Make Good to all damages & Paint As Per Architects Instructions
- 9 13mm gib board ceiling on timber framing with P50 shadowline stopping angle to be painted as per Architects instructions

- 10 Railing as per detail
- 11 Allow to remove all A/C outdoor units and installed to new location as per services drawings. Contractor to allow to make good to all damages.
- 12 Allow to remove existing Main Switch Board and relocate to new location as marked in electrical drawings. Contractor to allow to make good to all damages.
- 13 Allow to demolish existing concrete steps & railing shown dotted & make good to all damages.
- 14 Existing concrete wall / timber to remain, allow to make good to all damages & to be painted as per Architects instruction
- 15 Existing concrete column & beam to remain, allow to make good to all damages & to be painted as per Architects instruction
- 16 Existing floor tiles to remain as it is, allow to protect from damage during construction
- 17 Stair as per details

Copyright reserved in all drawings and the work excuted from them. Figured dimensions shall be read in preferance. Largest scaled drawings shall take precedence. Check all dimensions on site. All discrepancies shall be reported to the **ARCHITECT** immediately

REV. NOTES


REV. NOTES

REV. NOTES

REV. NOTES

REV. NOTES

PROJECT
PACIFIC COMMUNITY
PROPOSED EXTENSION TO EXISTING
BUILDING - CRYOGENIC LAB
FNTC ROAD 2, NARERE,
NASINU.

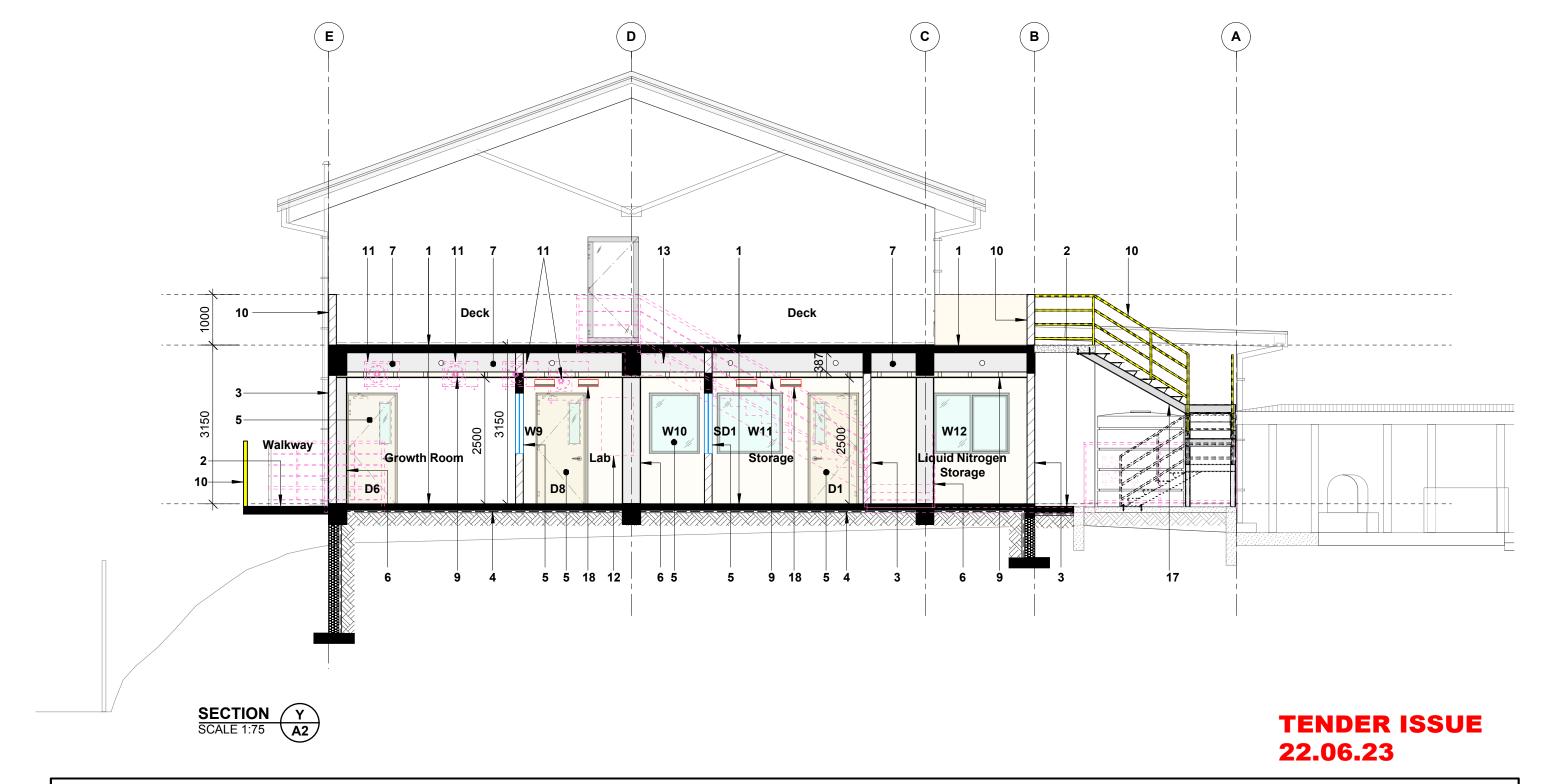

- 1 Concrete floor with selected tile finish refer floor plans
- 2 Steel trowel finish with soft broom finish as approved by the Architect.
- 3 Concrete blockwall plastered & painted from bothsides as per Architects instruction
- 4 Polythene dpc on 50 mm sand blinding and 100 well compacted hardcore fill
- 5 Door / window as per detail

- 6 Concrete column refer structural drawing for details. Column to be plastered & painted as per Architects instruction
- 7 Concrete beam, refer structural drawing for size & fixing
- 8 Existing ceiling to Remain, Allow to Make Good to all damages & Paint As Per Architects Instructions
- 9 13mm gib board ceiling on timber framing with P50 shadowline stopping angle to be painted as per Architects instructions

- 10 Railing as per detail
- 11 Allow to remove all A/C outdoor units and installed to new location as per services drawings. Contractor to allow to make good to all damages.
- 12 Allow to remove existing Main Switch Board and relocate to new location as marked in electrical drawings. Contractor to allow to make good to all damages.
- 13 Allow to demolish existing concrete steps & railing shown dotted & make good to all damages.

DATE


- 14 Existing concrete wall / timber to remain, allow to make good to all damages & to be painted as per Architects instruction
- 15 Existing concrete column & beam to remain, allow to make good to all damages & to be painted as per Architects instruction
- 16 Existing floor tiles to remain as it is, allow to protect from damage during construction
- 17 Stair as per details

18 Supply Air Grille as per mechanical drawing

Copyright reserved in all drawings and the work excuted from them. Figured dimensions shall be read in preferance. Largest scaled drawings shall take precedence. Check all dimensions on site. All discrepancies shall be reported to the **ARCHITECT** immediately

ARCHITECTS, DESIGN CONSULTANTS, PROJECT MANAGERS, INTERIOR DESIGNERS
26 MARA ROAD, P.O.BOX 16, NAUSORI, FIJI ISLANDS
PH. - 3400 287, FAX. - 3400 185

PROJECT
PACIFIC COMMUNITY
PROPOSED EXTENSION TO EXISTING
BUILDING - CRYOGENIC LAB
FNTC ROAD 2, NARERE,
NASINU.

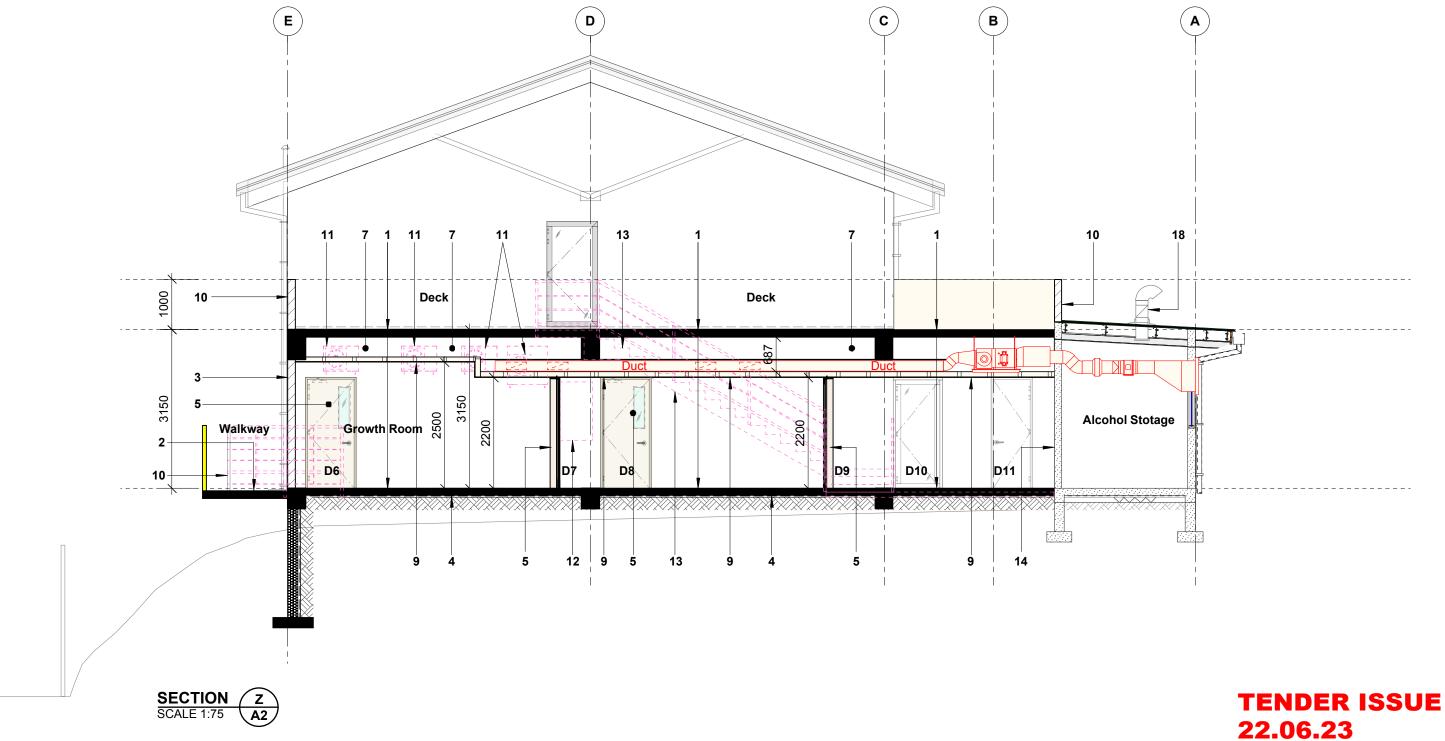

- 1 Concrete floor with selected tile finish refer floor plans
- 2 Steel trowel finish with soft broom finish as approved by the Architect.
- 3 Concrete blockwall plastered & painted from bothsides as per Architects instruction
- 4 Polythene dpc on 50 mm sand blinding and 100 well compacted hardcore fill
- 5 Door / window as per detail

- 6 Concrete column refer structural drawing for details. Column to be plastered & painted as per Architects instru
- 7 Concrete size & fix
- 8 Existing to all dan Instruction
- 9 13mm g with P50 painted

- 10 Railing as per detail
- 11 Allow to remove all A/C outdoor units and
- 14 Existing concrete wall / timber to remain, allow to make good to all damages & to be

rchitects instruction	installed to new location as per services	painted as per Architects instruction
rete beam, refer structural drawing for a fixing	drawings. Contractor to allow to make good to all damages.	Existing concrete column & beam to remain, allow to make good to all damages & to be
ng ceiling to Remain, Allow to Make Good damages & Paint As Per Architects ctions	and relocate to new location as marked in	painted as per Architects instruction Existing floor tiles to remain as it is, allow to protect from damage during construction
n gib board ceiling on timber framing P50 shadowline stopping angle to be ed as per Architects instructions	13 Allow to demolish existing concrete steps & railing shown dotted & make good to all damages.	17 Stair as per details


Copyright reserved in all drawings and the work excuted from them. Figured dimensions shall be read in preferance. Largest scaled drawings shall take precedence. Check all dimensions on site. All discrepancies shall be reported to the **ARCHITECT** immediately

E	design 1
II	ARCHITECTS, DESIGN CONSULTANTS, PROJECT MANAGERS, INTERIOR DESIGN
I	26 MARA ROAD , P.O.BOX 16 , NAUSORI , FIJI ISLANDS
/	PH 3400 287 , FAX 3400 185

REV.	NOTES	DATE	PROJECT
			PACIFIC COMMUNITY PROPOSED EXTENSION TO EXISTING
			BUILDING - CRYOGENIC LAB
			FNTC ROAD 2, NARERE, NASINU.

SHEET TITLE	DESIGN	:	S.P	PROJE	CT N	10. 2	22-01	14
SECTION	DRAWN	:	R.M/D.V.D	SHEET NO.			_	
	DATE	:	20.01.23				<u>\1</u>	0
	SCALE	:	1:75	REV.				

18 200x200 EA riser as per mechanical drawing

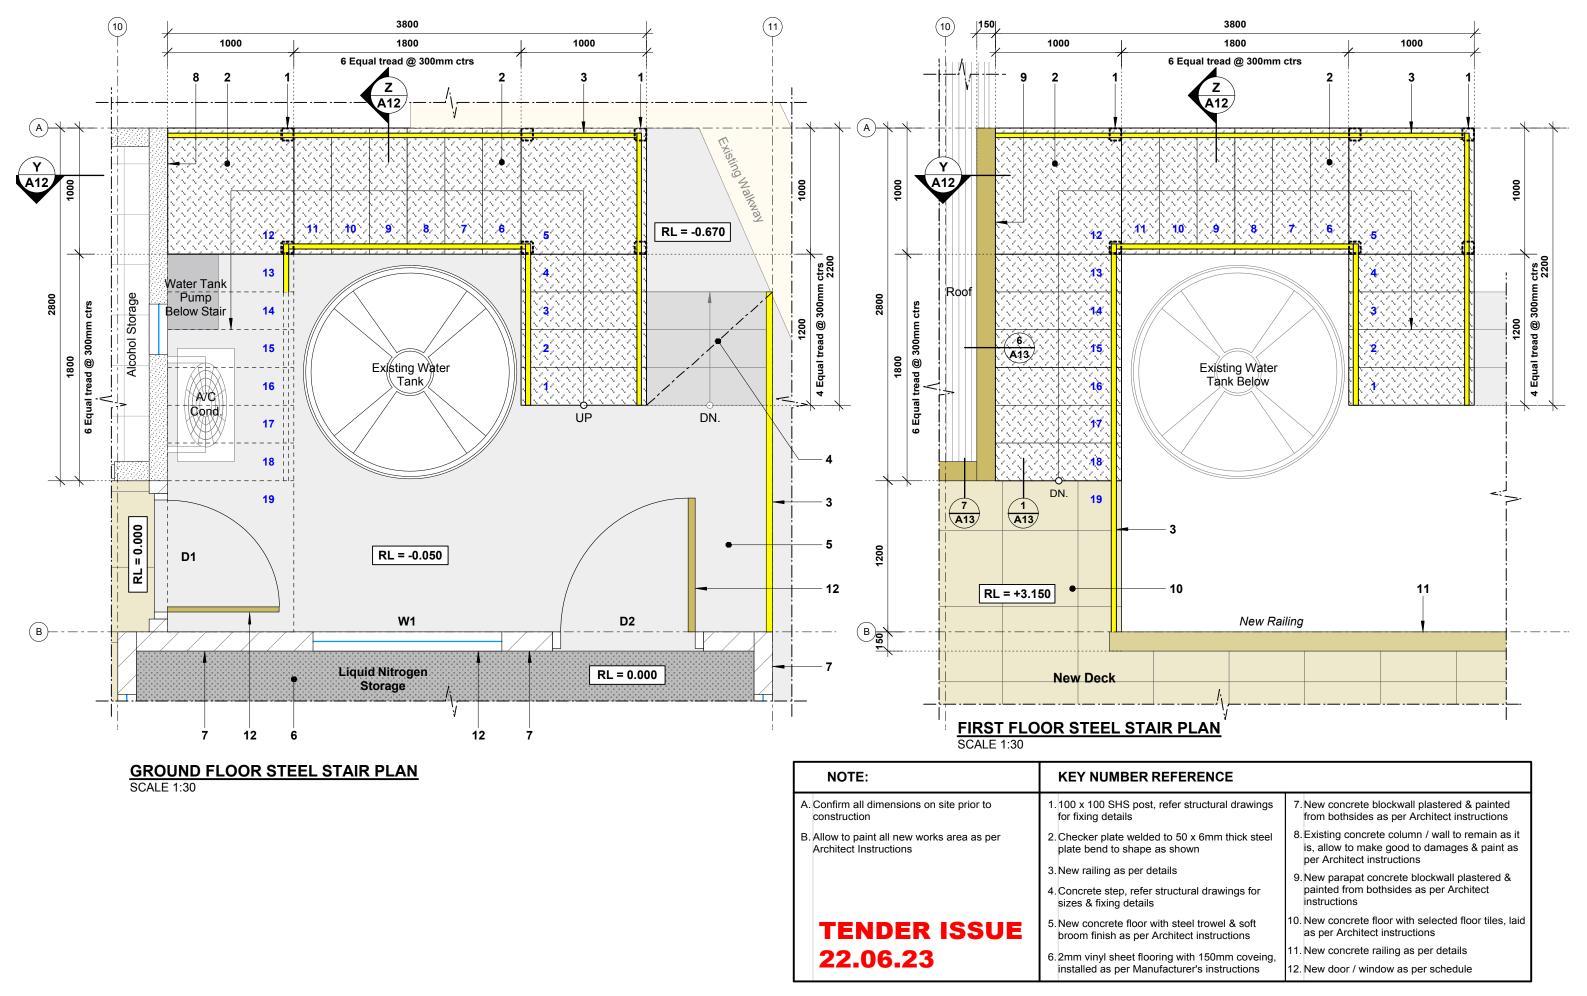

Copyright reserved in all drawings and the
work excuted from them. Figured dimensions
shall be read in preferance. Largest scaled
drawings shall take precedence. Check all
dimensions on site. All discrepancies shall
be reported to the ARCHITECT immediately

<u> </u>	design t	REV.	NOTES	DATE
dh	design 1			
	NSULTANTS,PROJECT MANAGERS,INTERIOR DESIGNERS			
	H 3400 287 , FAX 3400 185 nail : designhut@connect.com.fj			

PROJECT
PACIFIC COMMUNITY
PROPOSED EXTENSION TO EXISTING
BUILDING - CRYOGENIC LAB
FNTC ROAD 2, NARERE,
NASINU.


SHEET TITLE
STEEL STAIR PLAN


 DESIGN : S.P
 PROJECT NO.
 22-014


 DRAWN : S.S.N
 SHEET NO.


 DATE : 24.08.22
 A 1 1


 SCALE : AS SHOWN
 REV.

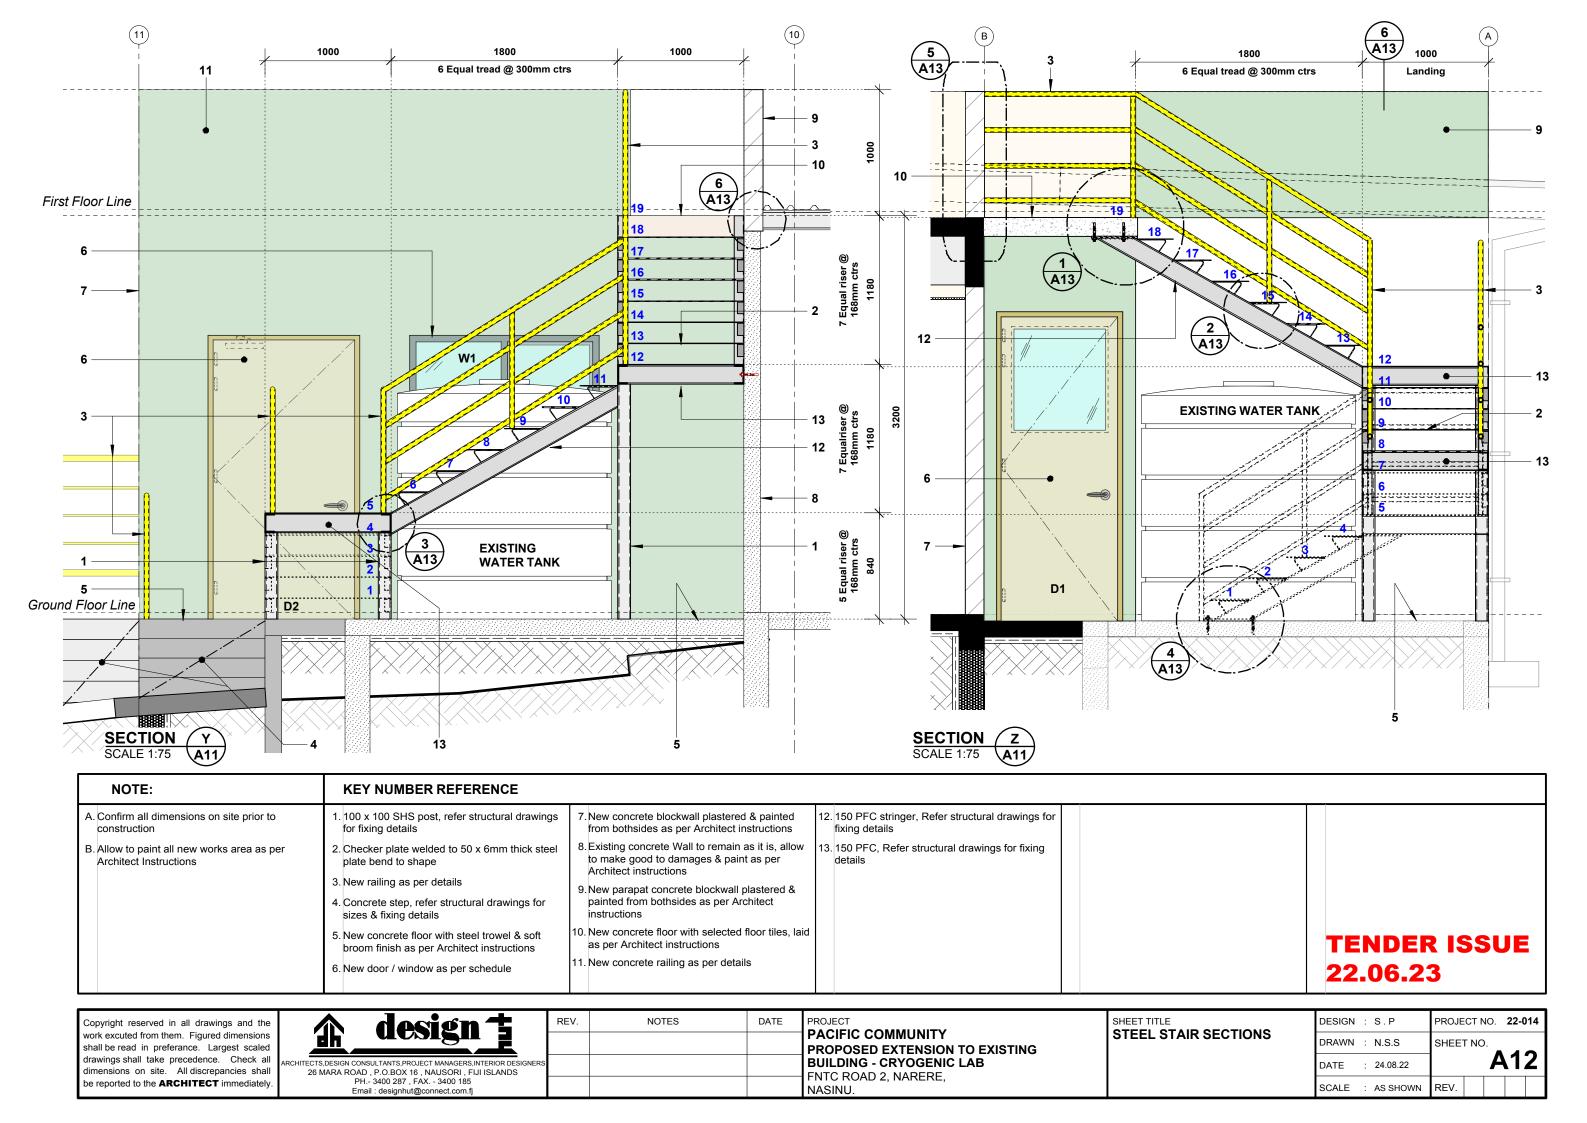

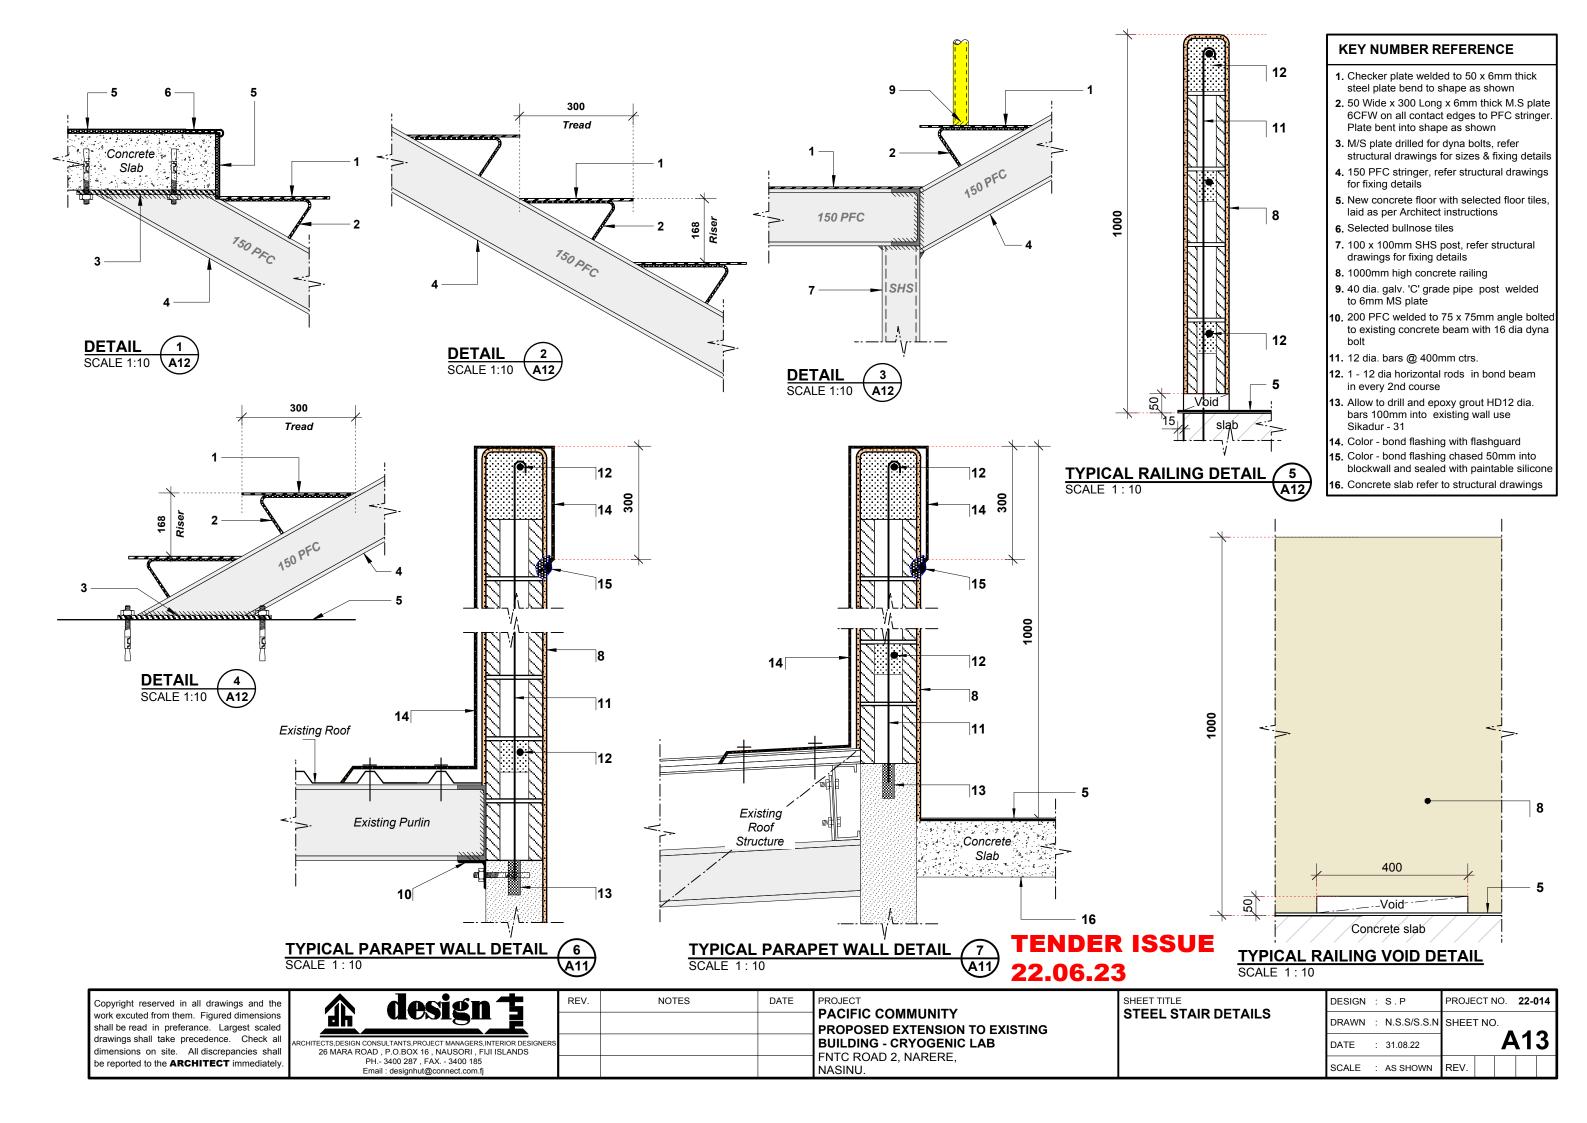

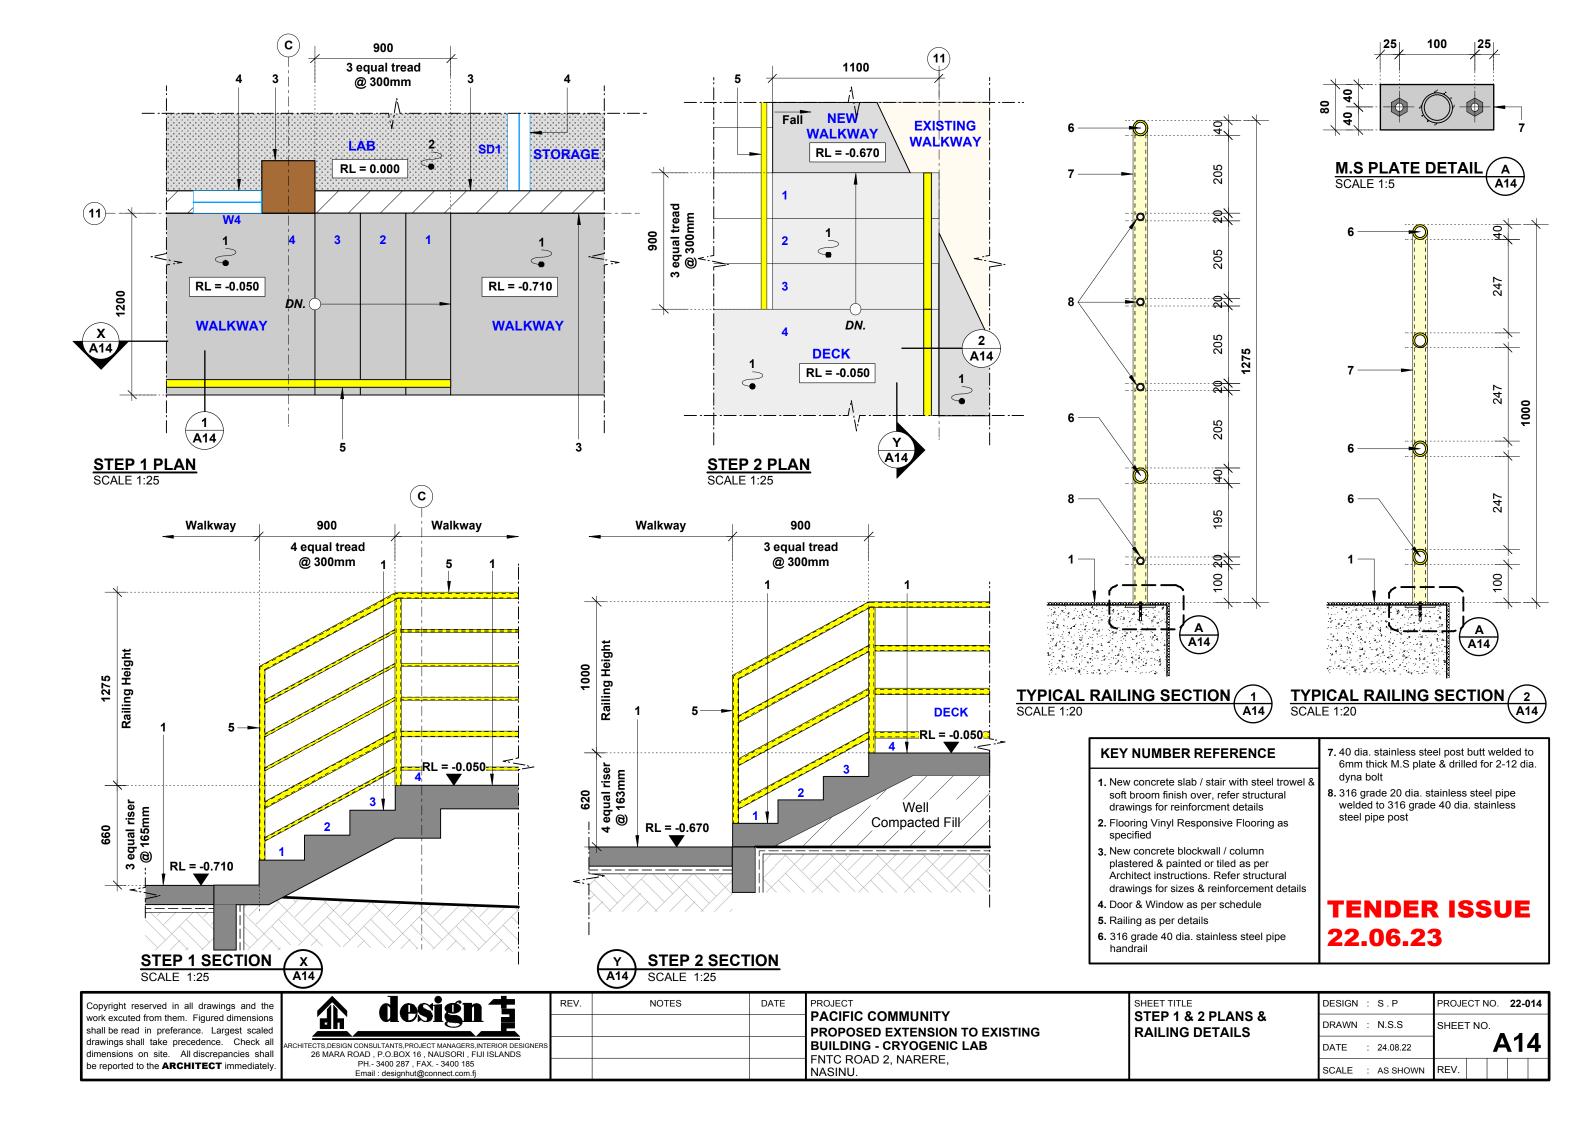

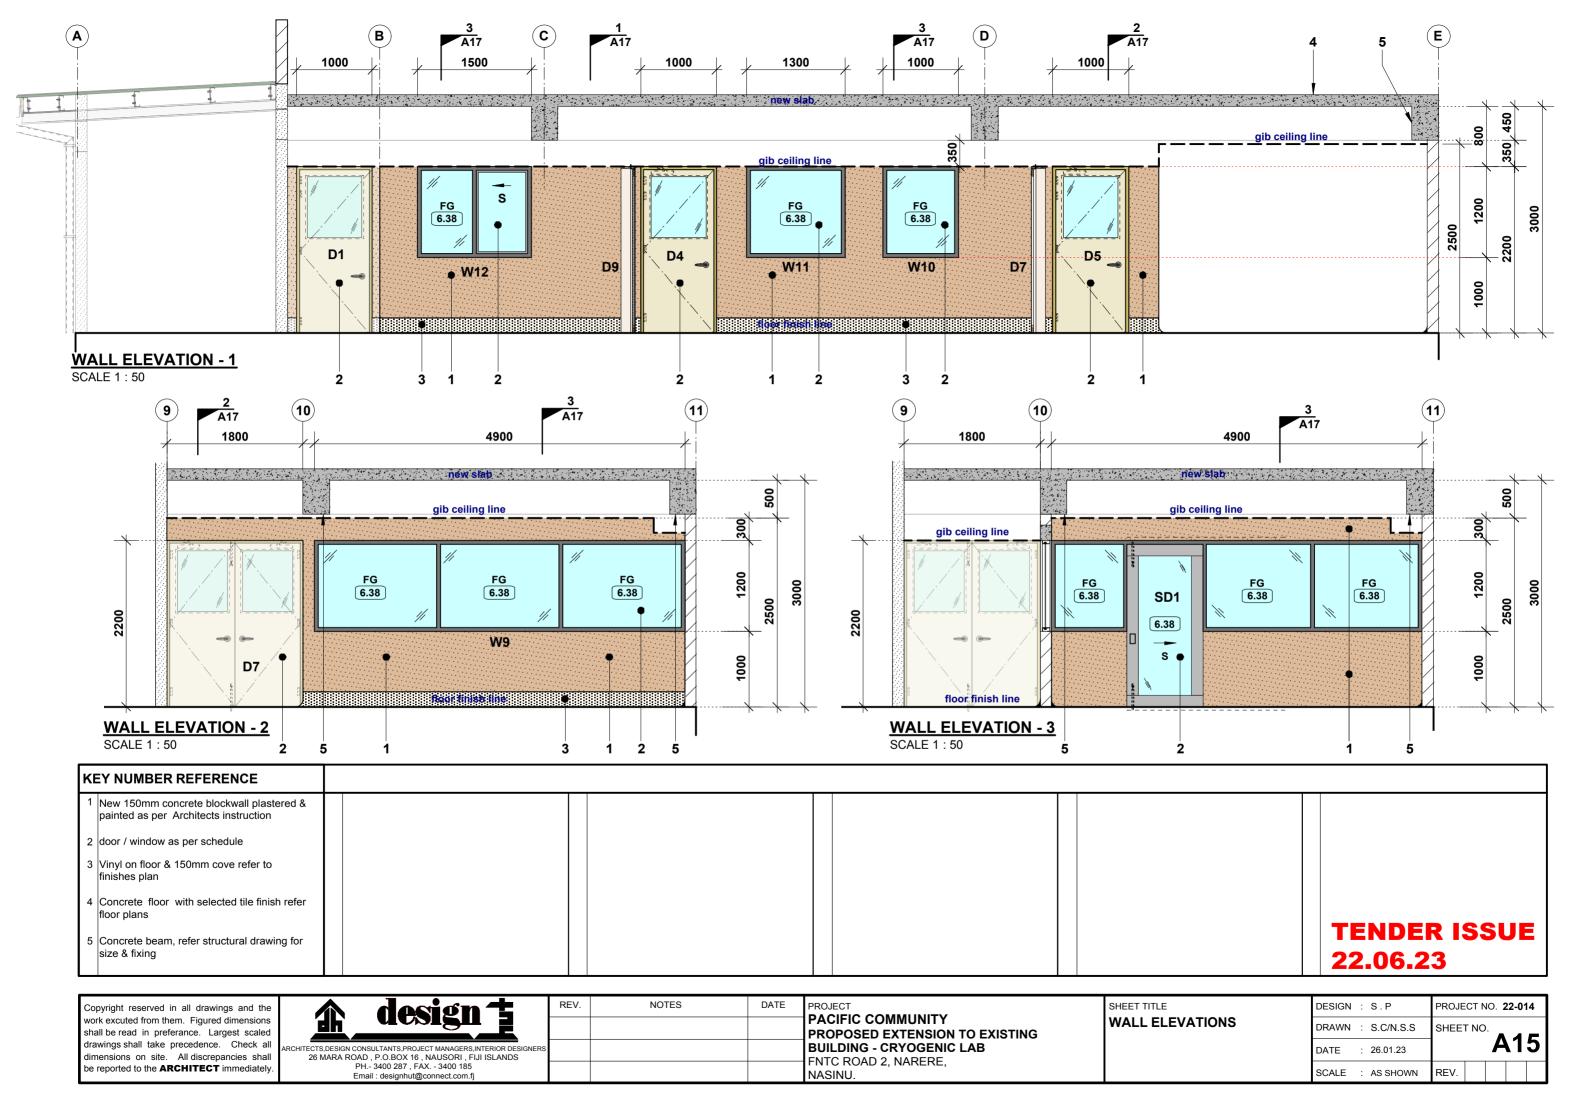

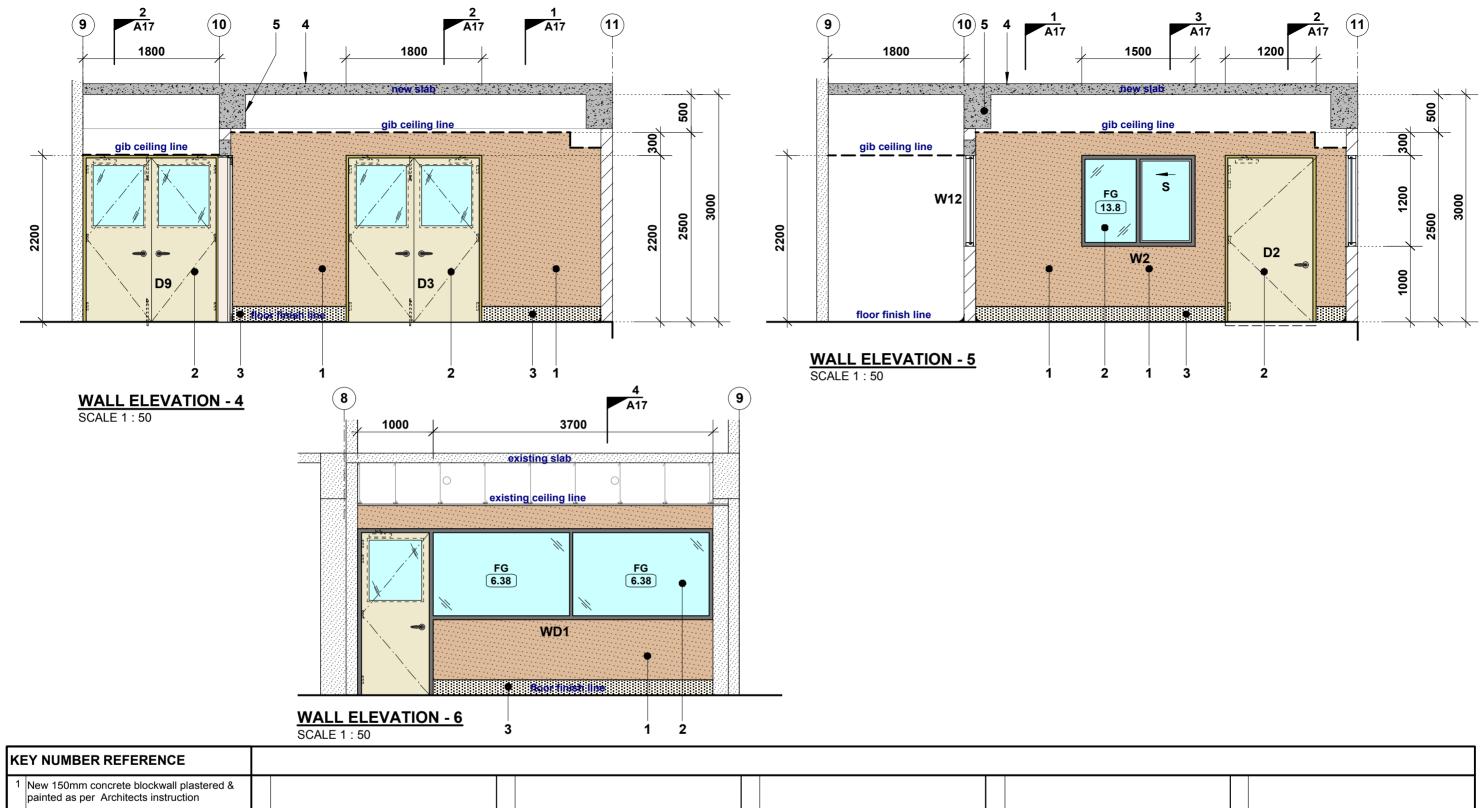

⊢				
	New 150mm concrete blockwall plastered & painted as per Architects instruction			
2	door / window as per schedule			
3	Vinyl on floor & 150mm cove refer to finishes plan			
4	Concrete floor with selected tile finish refer floor plans			TENDED ISSUE
5	Concrete beam, refer structural drawing for size & fixing			TENDER ISSUE 22.06.23

Copyright reserved in all drawings and the work excuted from them. Figured dimensions shall be read in preferance. Largest scaled drawings shall take precedence. Check all dimensions on site. All discrepancies shall be reported to the **ARCHITECT** immediately.

ARCHITECTS, DESIGN CONSULTANTS, PROJECT MANAGERS, INTERIOR DESIGNEF 26 MARA ROAD , P.O.BOX 16 , NAUSORI , FIJI ISLANDS PH.- 3400 287 , FAX. - 3400 185

REV.

PROJECT
PACIFIC COMMUNITY
PROPOSED EXTENSION TO EXISTING
BUILDING - CRYOGENIC LAB
FNTC ROAD 2, NARERE,
NASINU.


SHEET TITLE
WALL ELEVATIONS


 DESIGN : S. P
 PROJECT NO. 22-014

 DRAWN : S.C/N.S.S
 SHEET NO.

 DATE : 26.01.23
 A16

 SCALE : AS SHOWN
 REV.

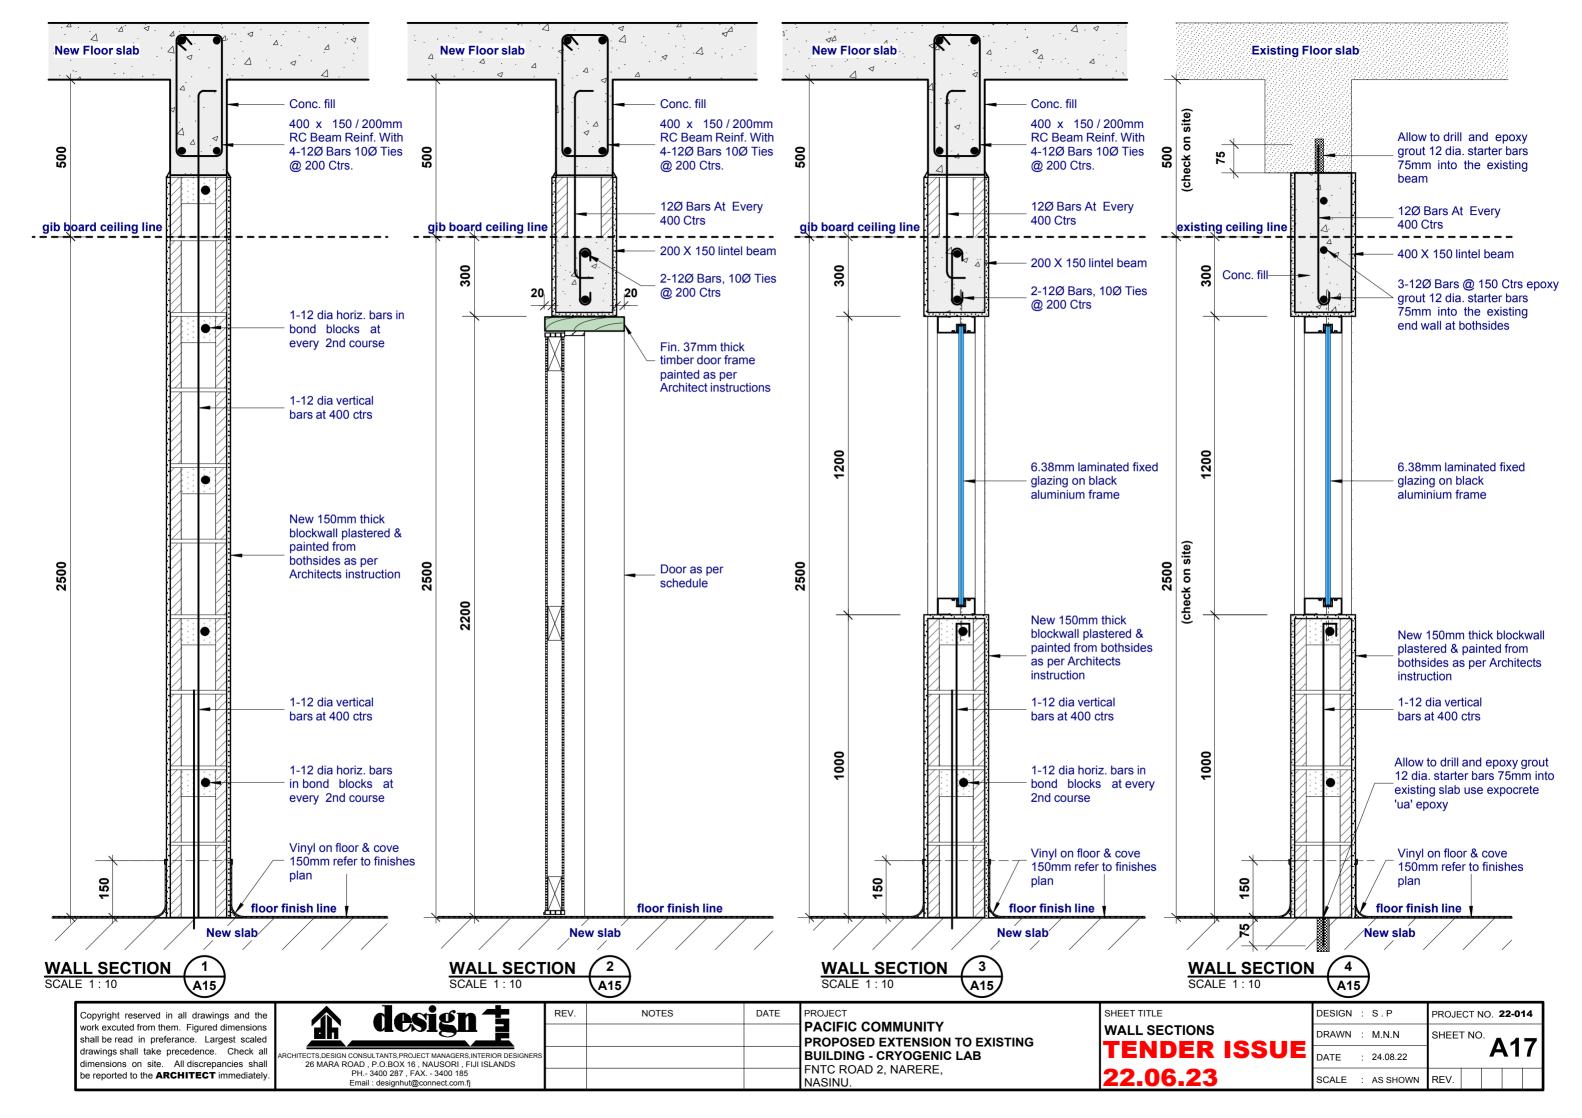

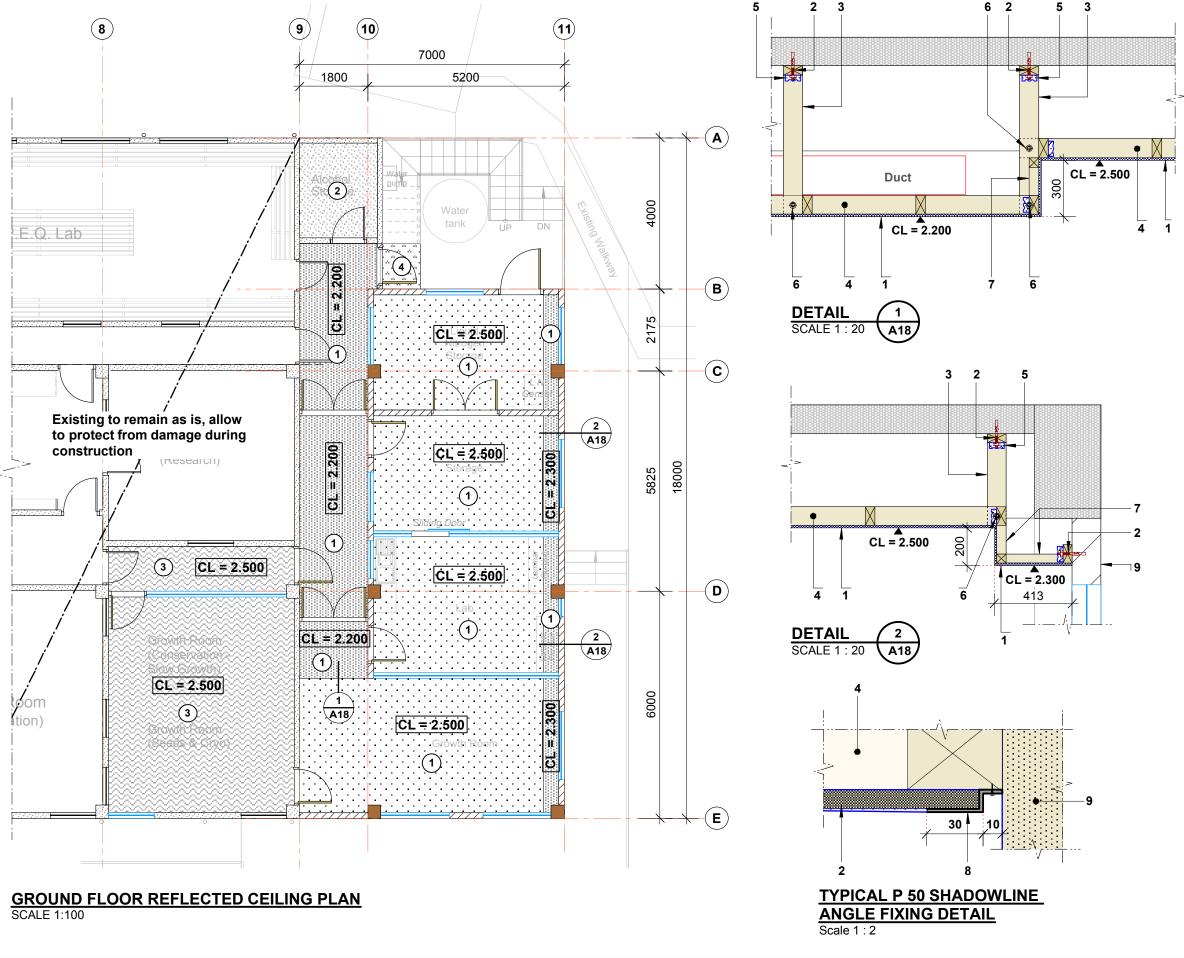

22.06.23
SHEET TITLE DESIGN S. P. PROJECT NO.

Copyright reserved in all drawings and the work excuted from them. Figured dimensions shall be read in preferance. Largest scaled drawings shall take precedence. Check all dimensions on site. All discrepancies shall be reported to the **ARCHITECT** immediately.

ARCHITECTS, DESIGN CONSULTANTS, PROJECT MANAGERS, INTERIOR DESIGN 26 MARA ROAD, P.O.BOX 16, NAUSORI, FIJI ISLANDS PH. 3400 287, FAX. - 3400 185 Email: designhut@connect.com.fj

REV. NOTES DATE PROJECT PACIFIC PROPOS BUILDIN FNTC RC NASINU.

PROJECT
PACIFIC COMMUNITY
PROPOSED EXTENSION TO EXISTING
BUILDING - CRYOGENIC LAB
FNTC ROAD 2, NARERE,

GROUND FLOOR REFLECTED
CEILING PLAN

DESIGN	:	S.P	PROJE	CT N	NO.	22-0	14
DRAWN	:	R.M.	SHEE	TNC		4	0
DATE	:	26.01.23			μ	1	Ö
SCALE	:	AS SHOWN	REV.				

NOTES

All Ceiling Heights Are From Finished
 Floor Level

LEGEND:

1

(1)

13mm Gib Board On Timber Framing With P50 Shadowline Stopping Angle & Different Ceiling Heights, Boards To Be Painted As Per Architects Instructions



Existing ceiling to remain, allow to protect from damages during construction



Existing ceiling to remain, Allow to Make Good to all damages & Paint As Per Architects Instructions




Underside Of Slab To Be Plastered & Painted As Per Architects Instruction

KEY NUMBER REFERENCE

- 1 13mm gib board ceiling on timber framing to be painted as per Architects instructions
- 2 Ex. 100 x 50mm timber plate fix to R.C beam / conc. wall & slab with 12 dia. dyna bolt @ 900mm ctrs
- 3 Ex. 100 x 50mm timber hangers @ 1200mn ctrs fixed to slab as required
- 4 Ex. 100 x 50 timber framing @ 600mm ctrs bothways
- 5 Multigrip from bothsides use 5 30 x 3.15 dia burgle headed nails all holes filled
- 6 1-12 dia. bolt
- 7 Ex. 50 x 50 timber framing @ 600mm ctrs bothways
- 8 P 50 shadowline stopping angle all around
- 9 150 conc. wall plastered & painted from bothsides as per Architects instructions

TENDER ISSUE

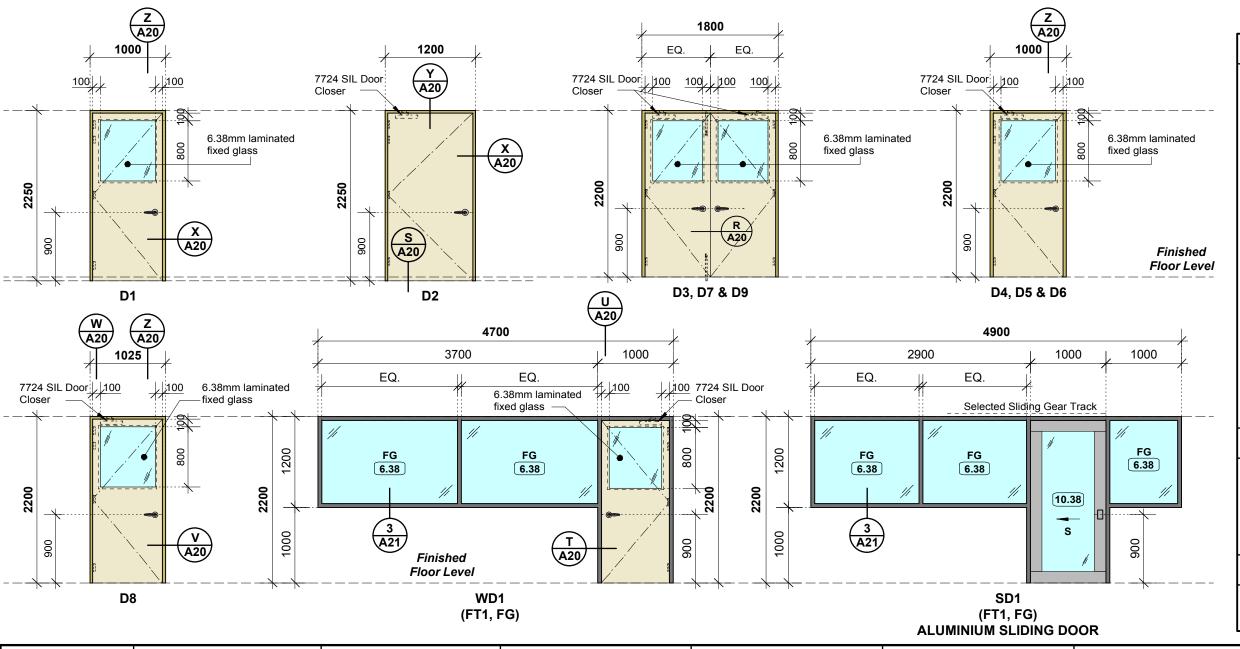

NOTE:

- A. Contractor to confirm all opening sizes on site prior to fabricating doors & windows
- **B.** All doors to have 1.5 or 2 pairs stainless steel hinges per door leaf unless noted elsewhere
- **C.** All door lock finish to be satin chrome with selected door handles
- D. Allow for floor mounted rubber door stoppers to all doors. Stoppers to be selected by Architect
- E. Provide malthoid D.P.C where timber comes in contact with concrete, D.P.C to be approved by Architect
- F. Raven weather strip to suit to all Exterior Doors
- G. Aluminium contractor to provide shop drawing to Architect / Engineer for approval prior to fabrication
- **H.** Aluminium profile to be approved by Architect
- J. Aluminium contractor to wrap all aluminium frames with plastic covering prior Installation on site
- K. Allow for a Master Key for the Fitout Area

 I. All doors to be painted as per Architect
- L. All doors to be painted as per Architect instructions

LEGEND:

FRAME TYPE:

FT1 100mm aluminium frame with powder coated black finish, sample to be approved by Architect

FIXED GLASS:

FG Laminated clear glazing

KEY:

6.38 6.38mm fixed laminated clear glazing glass

DOOR REF. No	D1	D2	D3	D4, D5, D6 & D8	D7 & D9	WD1	SD1	
DOOR TYPE	Solid Core Timber Door With 6mm Exterior Ply From Bothsides,	Solid Core Timber Door With 6mm Exterior Ply	h 6mm Exterior Ply 6mm Interior Ply From Bothsides, 6mm Interior Ply From Bothsides, 6mm Interior Ply From Bothsides, With 6mm Interior Fly		Solid Core Timber Door With 6mm Interior Ply From	Aluminium Sliding Door with 10.38mm Laminated Clear Glazing		
	With 6.38mm Laminated Clear Glass Insert as Shown	From Bothsides painted as per Architect instructions	With 6.38mm Laminated Clear Glass Insert as Shown	With 6.38mm Laminated Clear Glass Insert as Shown	With 6.38mm Laminated Clear Glass Insert as Shown	Bothsides painted as per Architect instructions	Natural Anodized Finish as approved by Architect	
DOOR FINISH	Spray Paint Finish as approved by Architect	Spray Paint Finish as approved by Architect	Spray Paint Finish as approved by Architect	Spray Paint Finish as approved by Architect	Spray Paint Finish as approved by Architect	Spray Paint Finish as approved by Architect	100mm Commercial Grade Aluminium Frame	
	· · · · · · · · · · · · · · · · · · ·	 '' 	1 '' '	1	1	 		
FRAME TYPE	Fin. 37mm Timber Frame	Fin. 37mm Timber Frame	Fin. 37mm Timber Frame	Fin. 37mm Timber Frame	Fin. 37mm Timber Frame	100mm Commercial Grade Aluminium Frame	Natural Anodized Finish as	
FRAME FINISH	Spray Paint Finish as approved by Architect	Spray Paint Finish as approved by Architect	Spray Paint Finish as approved by Architect	Spray Paint Finish as approved by Architect	Spray Paint Finish as approved by Architect	Natural Anodized Finish as approved by Architect	approved by Architect Lockwood Entry Set (Enable Series Set), allow for door stopper with selected push handle or Approved Equivalent - 14TA4N "Henderson" Sliding Track - E2FCA40N Channel - 144C4N Wheel - ATFGS Guide - 14TS Stopper - 1 Set 3641RT2SC Sliding Lock	
HARDWARE	Lockwood Entry Set (Enable Series Set), allow for door stopper & 2 pairs stainless steel hinges with 7724 SIL door closer or Approved Equivalent	Lockwood Entry Set (Enable Series Set), allow for door stopper & 2 pairs stainless steel hinges with 7724 SIL door closer or Approved Equivalent	Lockwood Entry Set (Enable Series Set), Provide flush bolts to top & bottom with dust socket & allow for door stopper & 1.5 pairs stainless steel hinges per door leaf with 7724 SIL door closer or Approved Equivalent	Lockwood Entry Set (Enable Series Set), allow for door stopper & 2 pairs stainless steel hinges with 7724 SIL door closer or Approved Equivalent	Lockwood Entry Set (Enable Series Set), Provide flush bolts to top & bottom with dust socket & allow for door stopper & stainless steel hinges per door leaf with 7724 SIL door closer or Approved Equivalent	Lockwood Entry Set (Enable Series Set), allow for door stopper & 2 pairs stainless steel hinges with 7724 SIL door closer & door handles or Approved Equivalent		


Copyright reserved in all drawings and the work excuted from them. Figured dimensions shall be read in preferance. Largest scaled drawings shall take precedence. Check all dimensions on site. All discrepancies shall be reported to the **ARCHITECT** immediately.


e s d	<u> </u>	esign ‡
ıll	ARCHITECTS, DESIGN CONSULTANT	TS,PROJECT MANAGERS,INTERIOR DESIGNER
ıll	26 MARA ROAD , P.O.E	BOX 16 , NAUSORI , FIJI ISLANDS
l۷.	PH 3400	287 , FAX 3400 185
,	Email : desi	gnhut@connect.com.fj

REV.	NOTES	DATE	PROJECT COMMUNITY
			PACIFIC COMMUNITY PROPOSED EXTENSION TO EXISTING
			BUILDING - CRYOGENIC LAB
			FNTC ROAD 2, NARERE, NASINU.


DE DOOR SCHEDULE
TENDER ISSUE
DA
22.06.23


DESIGN : S.P	PROJECT NO. 22-014
DRAWN : S.S.N	SHEET NO.
DATE : 24.08.22	A19
SCALE : 1:50	REV.

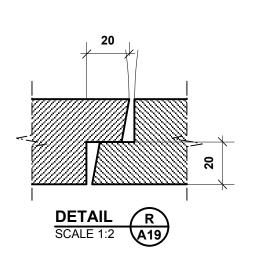

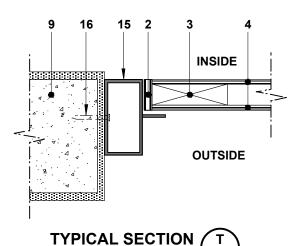

SCALE 1:5

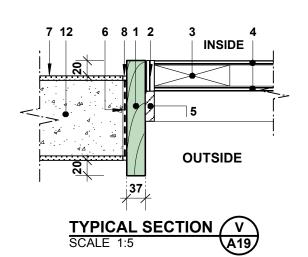

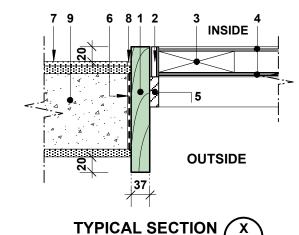



13. Selected 10 x 10mm Aluminium angle

KEY NUMBER REFERENCE:

4. 6mm Exterior / Interior ply lining from

5. Fin. 40 x 12mm stopper all around 6. Malthoid D.P.C between all direct contact

8. Flexible grout where applicable

9. Concrete blockwall plastered & painted

11. 6.38mm Laminated Clear Glazing with rubber gasket into 20 x 20mm beading

12. Existing concrete blockwall painted or

or tiled from bothsides as per Architect

as per Architect instructions 2. Fin. 10mm timber clashing all around 3. Fin. 90 x 28mm timber door rails / stiles

bothsides spray paint finish


of timber & concrete 7. Tiling where applicable

10. Fin. 20 x 20mm beading

instructions

1. Fin. 37mm thick timber door frame painted

- 14. Concrete floor as per finishes plan
- 15. Aluminium door frame with powder coated black finish
- **16.** 10G x 50mm Long stainless steel grade 316 screws fixed @ 250mm ctrs max. & 50mm away from corners

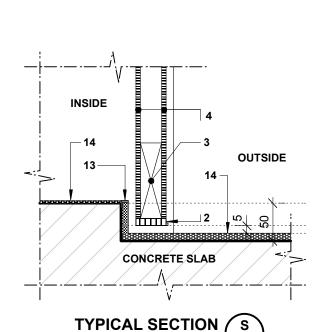

SCALE 1:5

Copyright reserved in all drawings and the


work excuted from them. Figured dimensions


shall be read in preferance. Largest scaled


drawings shall take precedence. Check all


dimensions on site. All discrepancies shall

be reported to the ARCHITECT immediately.

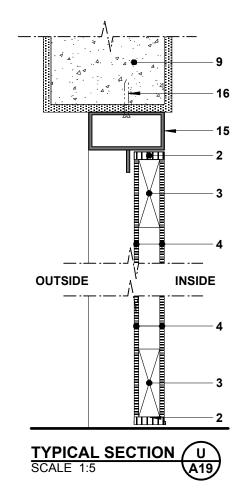

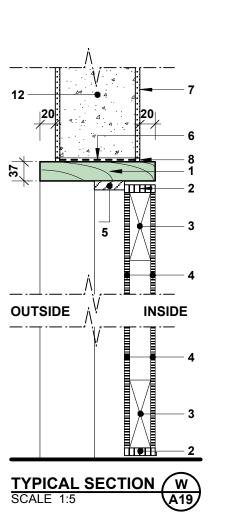

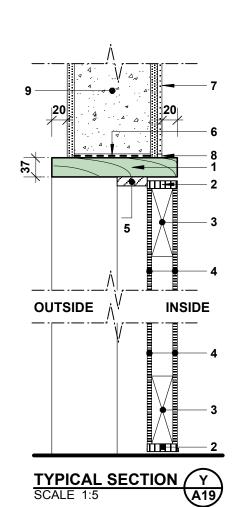

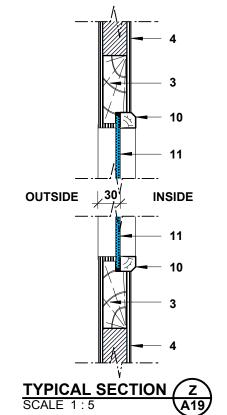



design 🕇	REV.	NOTES	DATE	PROJECT COMMUNITY
				PACIFIC COMMUNITY PROPOSED EXTENSION TO EXISTING
ILTANTS,PROJECT MANAGERS,INTERIOR DESIGNERS P.O.BOX 16 , NAUSORI , FIJI ISLANDS			l	BUILDING - CRYOGENIC LAB FNTC ROAD 2. NARERE.
3400 287 , FAX 3400 185 : designhut@connect.com.fj				NASINU.



DESIGN	: S.P	PROJECT NO. 22-014
DRAWN	: S.S.N	SHEET NO.
DATE	: 24.08.22	A20
SCALE	: AS SHOWN	REV.

