CLIENT: Pacific Community
Communauté du Pacifique


CONSULTANT:

NRW MACALLAN (FIJI) LTD

CONSULTING ENGINEERS

CIVIL, STRUCTURAL, ELECTRICAL, MECHANICAL & PROJECT MANAGEMENT


79 RATU MARA ROAD, SAMABULA, SUVA

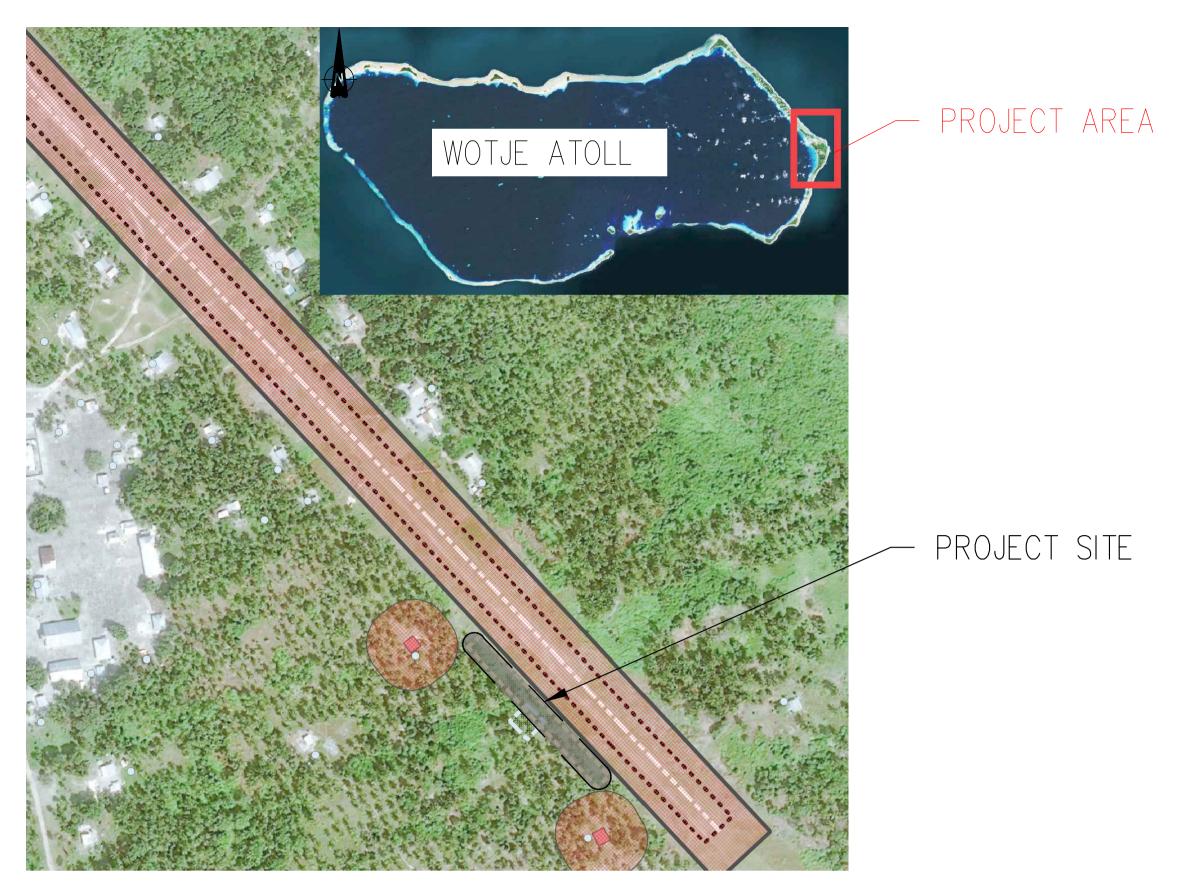


## LOCALITY PLAN

SCALE: NTS

	DRAWING SHEET SCHEDULES		
SHEET No.	SHEET TITLE	REV	DATE
G-001	COVER SHEET	OA	5-Oct-23
A-001	GALLERY TANK OVERHEAD FLOOR PLAN, BEAM LAYOUT AND SECTIONS PIPEWORK DETAILS	OA	5-0ct-23
A-002	FOUNDATION PLAN	OA	5-Oct-23
A-003	HEADER TANK, INLET PIPE WORK ELEVATIONS (BE & SE1)	OA	5-0ct-23
A-004	HEADER TANK, INLET PIPE WORK ELEVATIONS (FE & SE2)	OA	5-0ct-23
A-005	GALLERY TANK SECTION	OA	5-0ct-23
A-006	GENERAL PIPE WORK DETAILS	OA	5-0ct-23
A-007	GALLERY PUMP PIPE WORK SECTION (TYP.)	OA	5-Oct-23
A-008	GALLERY SECTION AND DETAIL	OA	5-Oct-23
A-009	COLUMN STRUCTURAL DETAILS, PAD FOOTINGS & TYPICAL SECTIONS	OA	5-Oct-23
A-010	COMMUNITY FILLING POINT SITE PLAN & TYPICAL SECTION	OA	5-0ct-23
A-011	SAFETY ACCESS CAGE LADDER AND TYPICAL HANDRAIL ELEVATIONS, SECTIONS AND DETAILS	OA	5-0ct-23

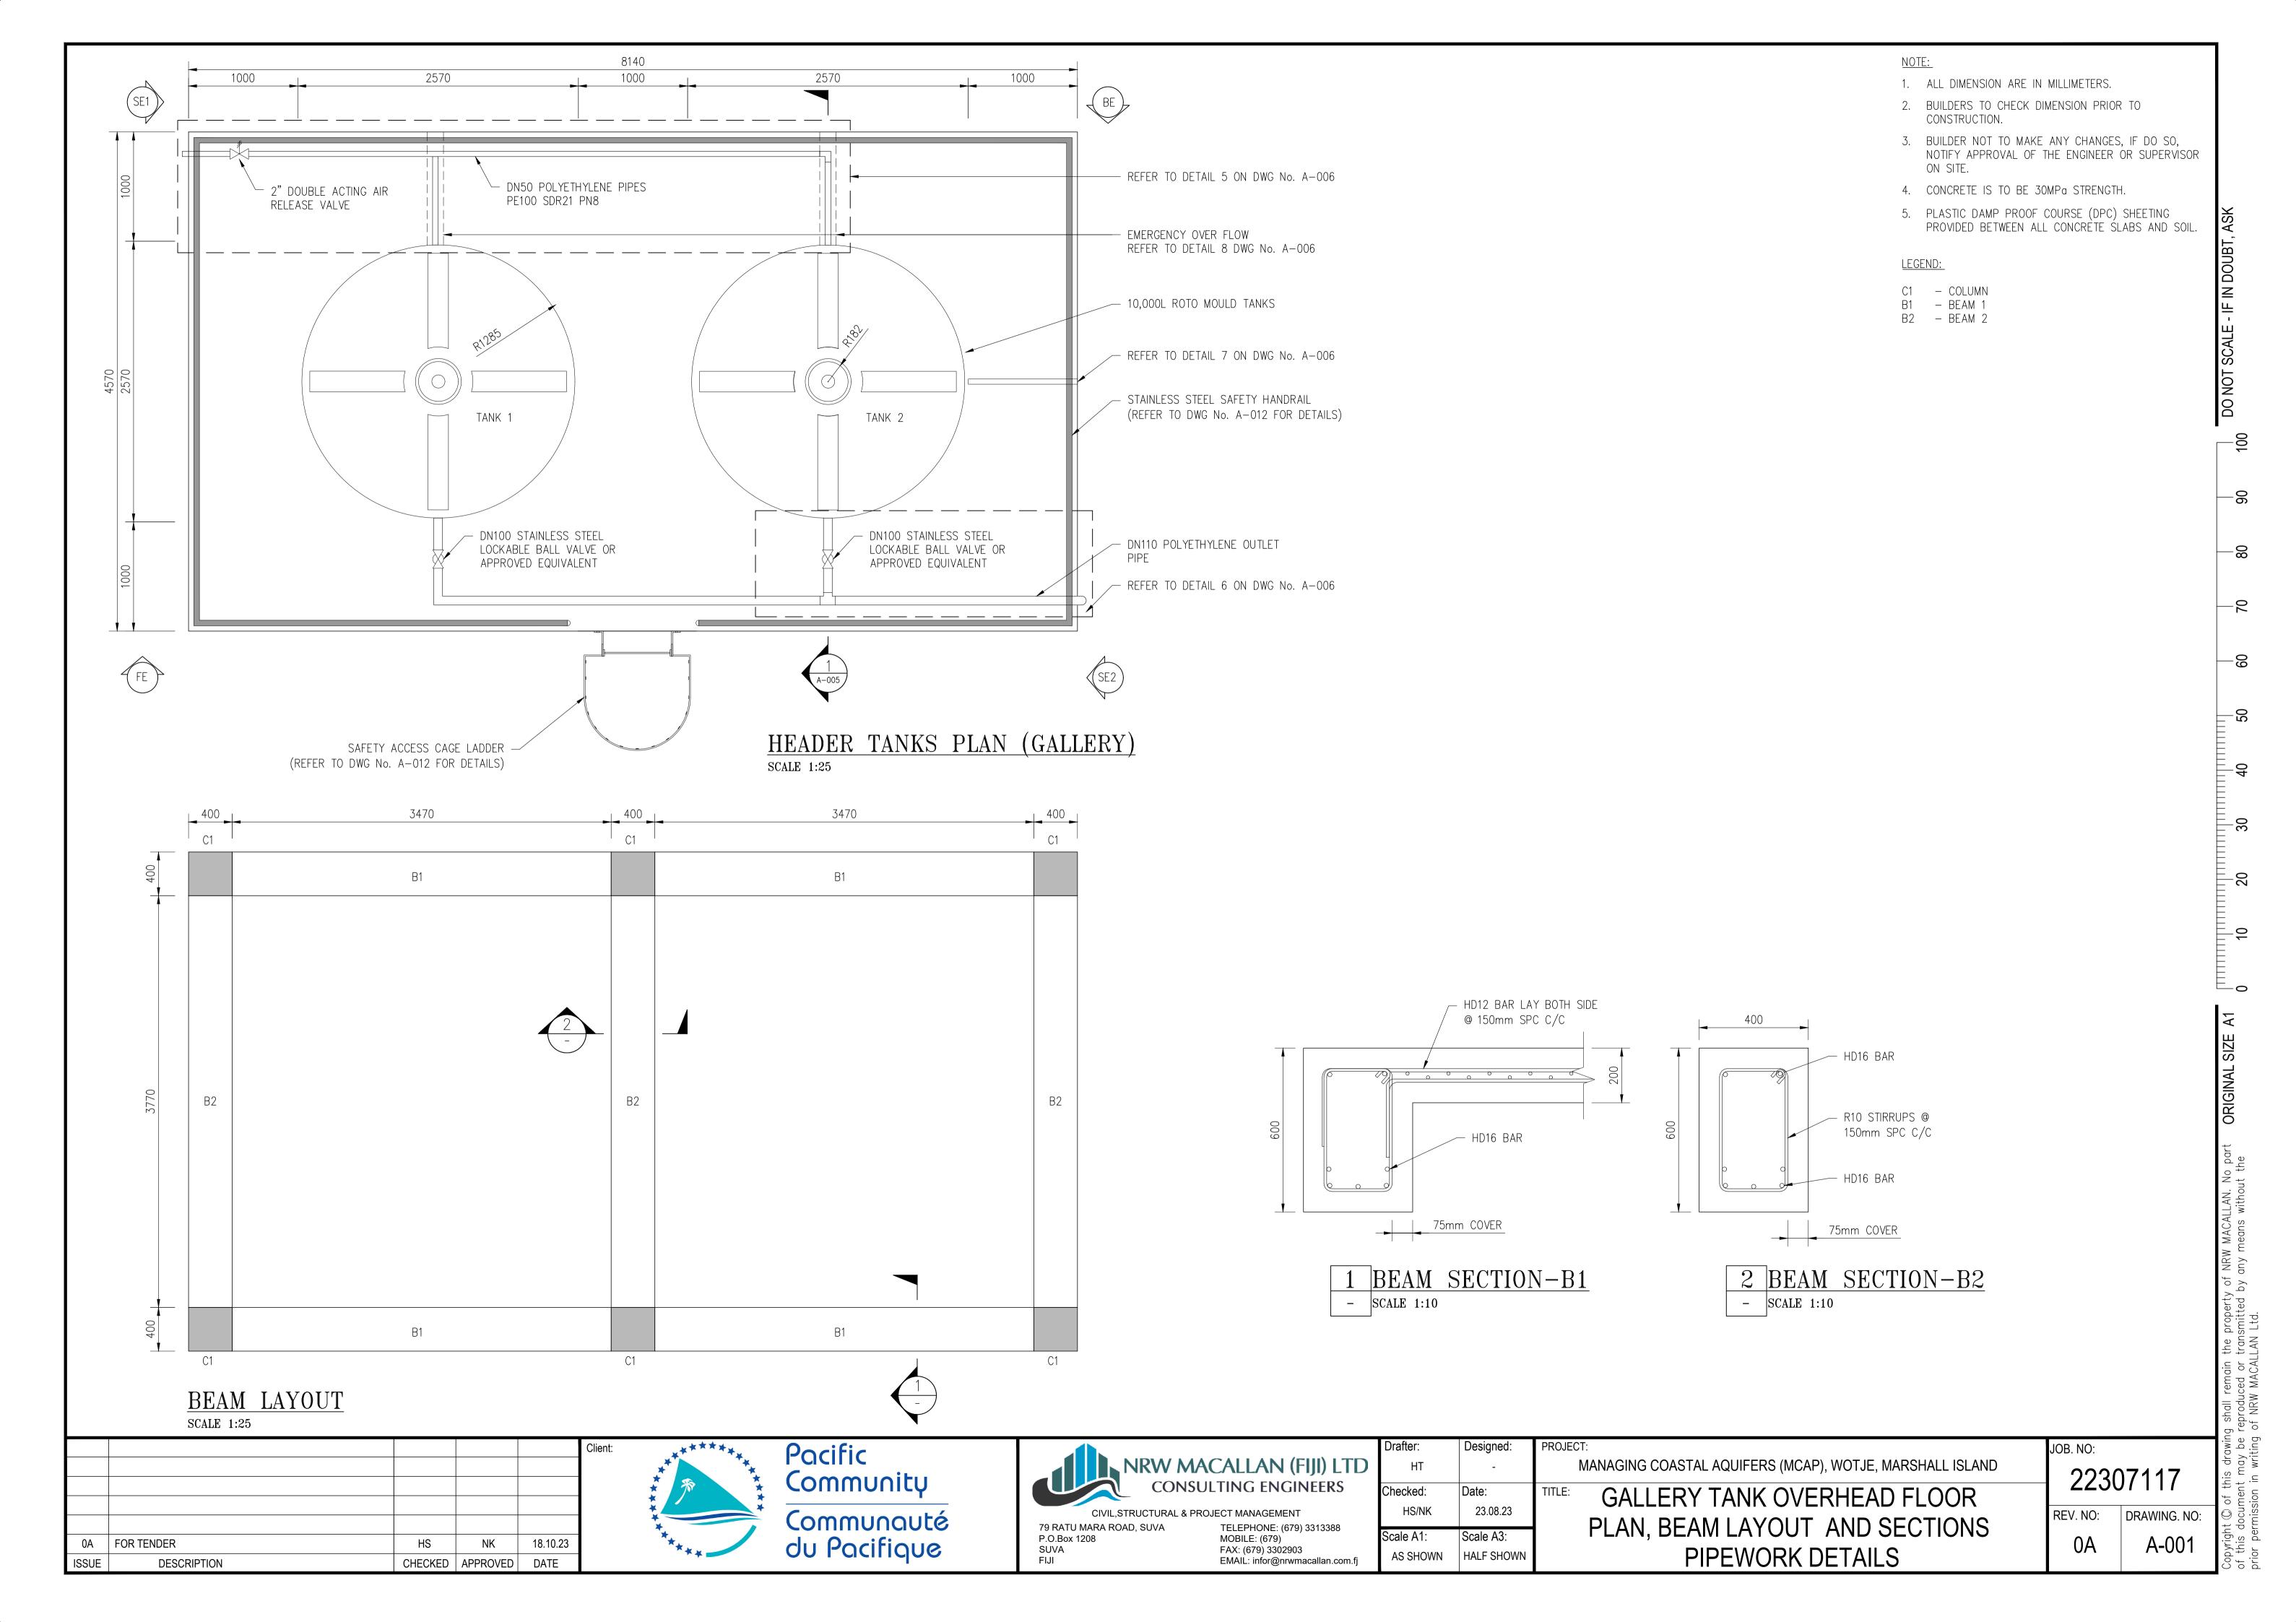

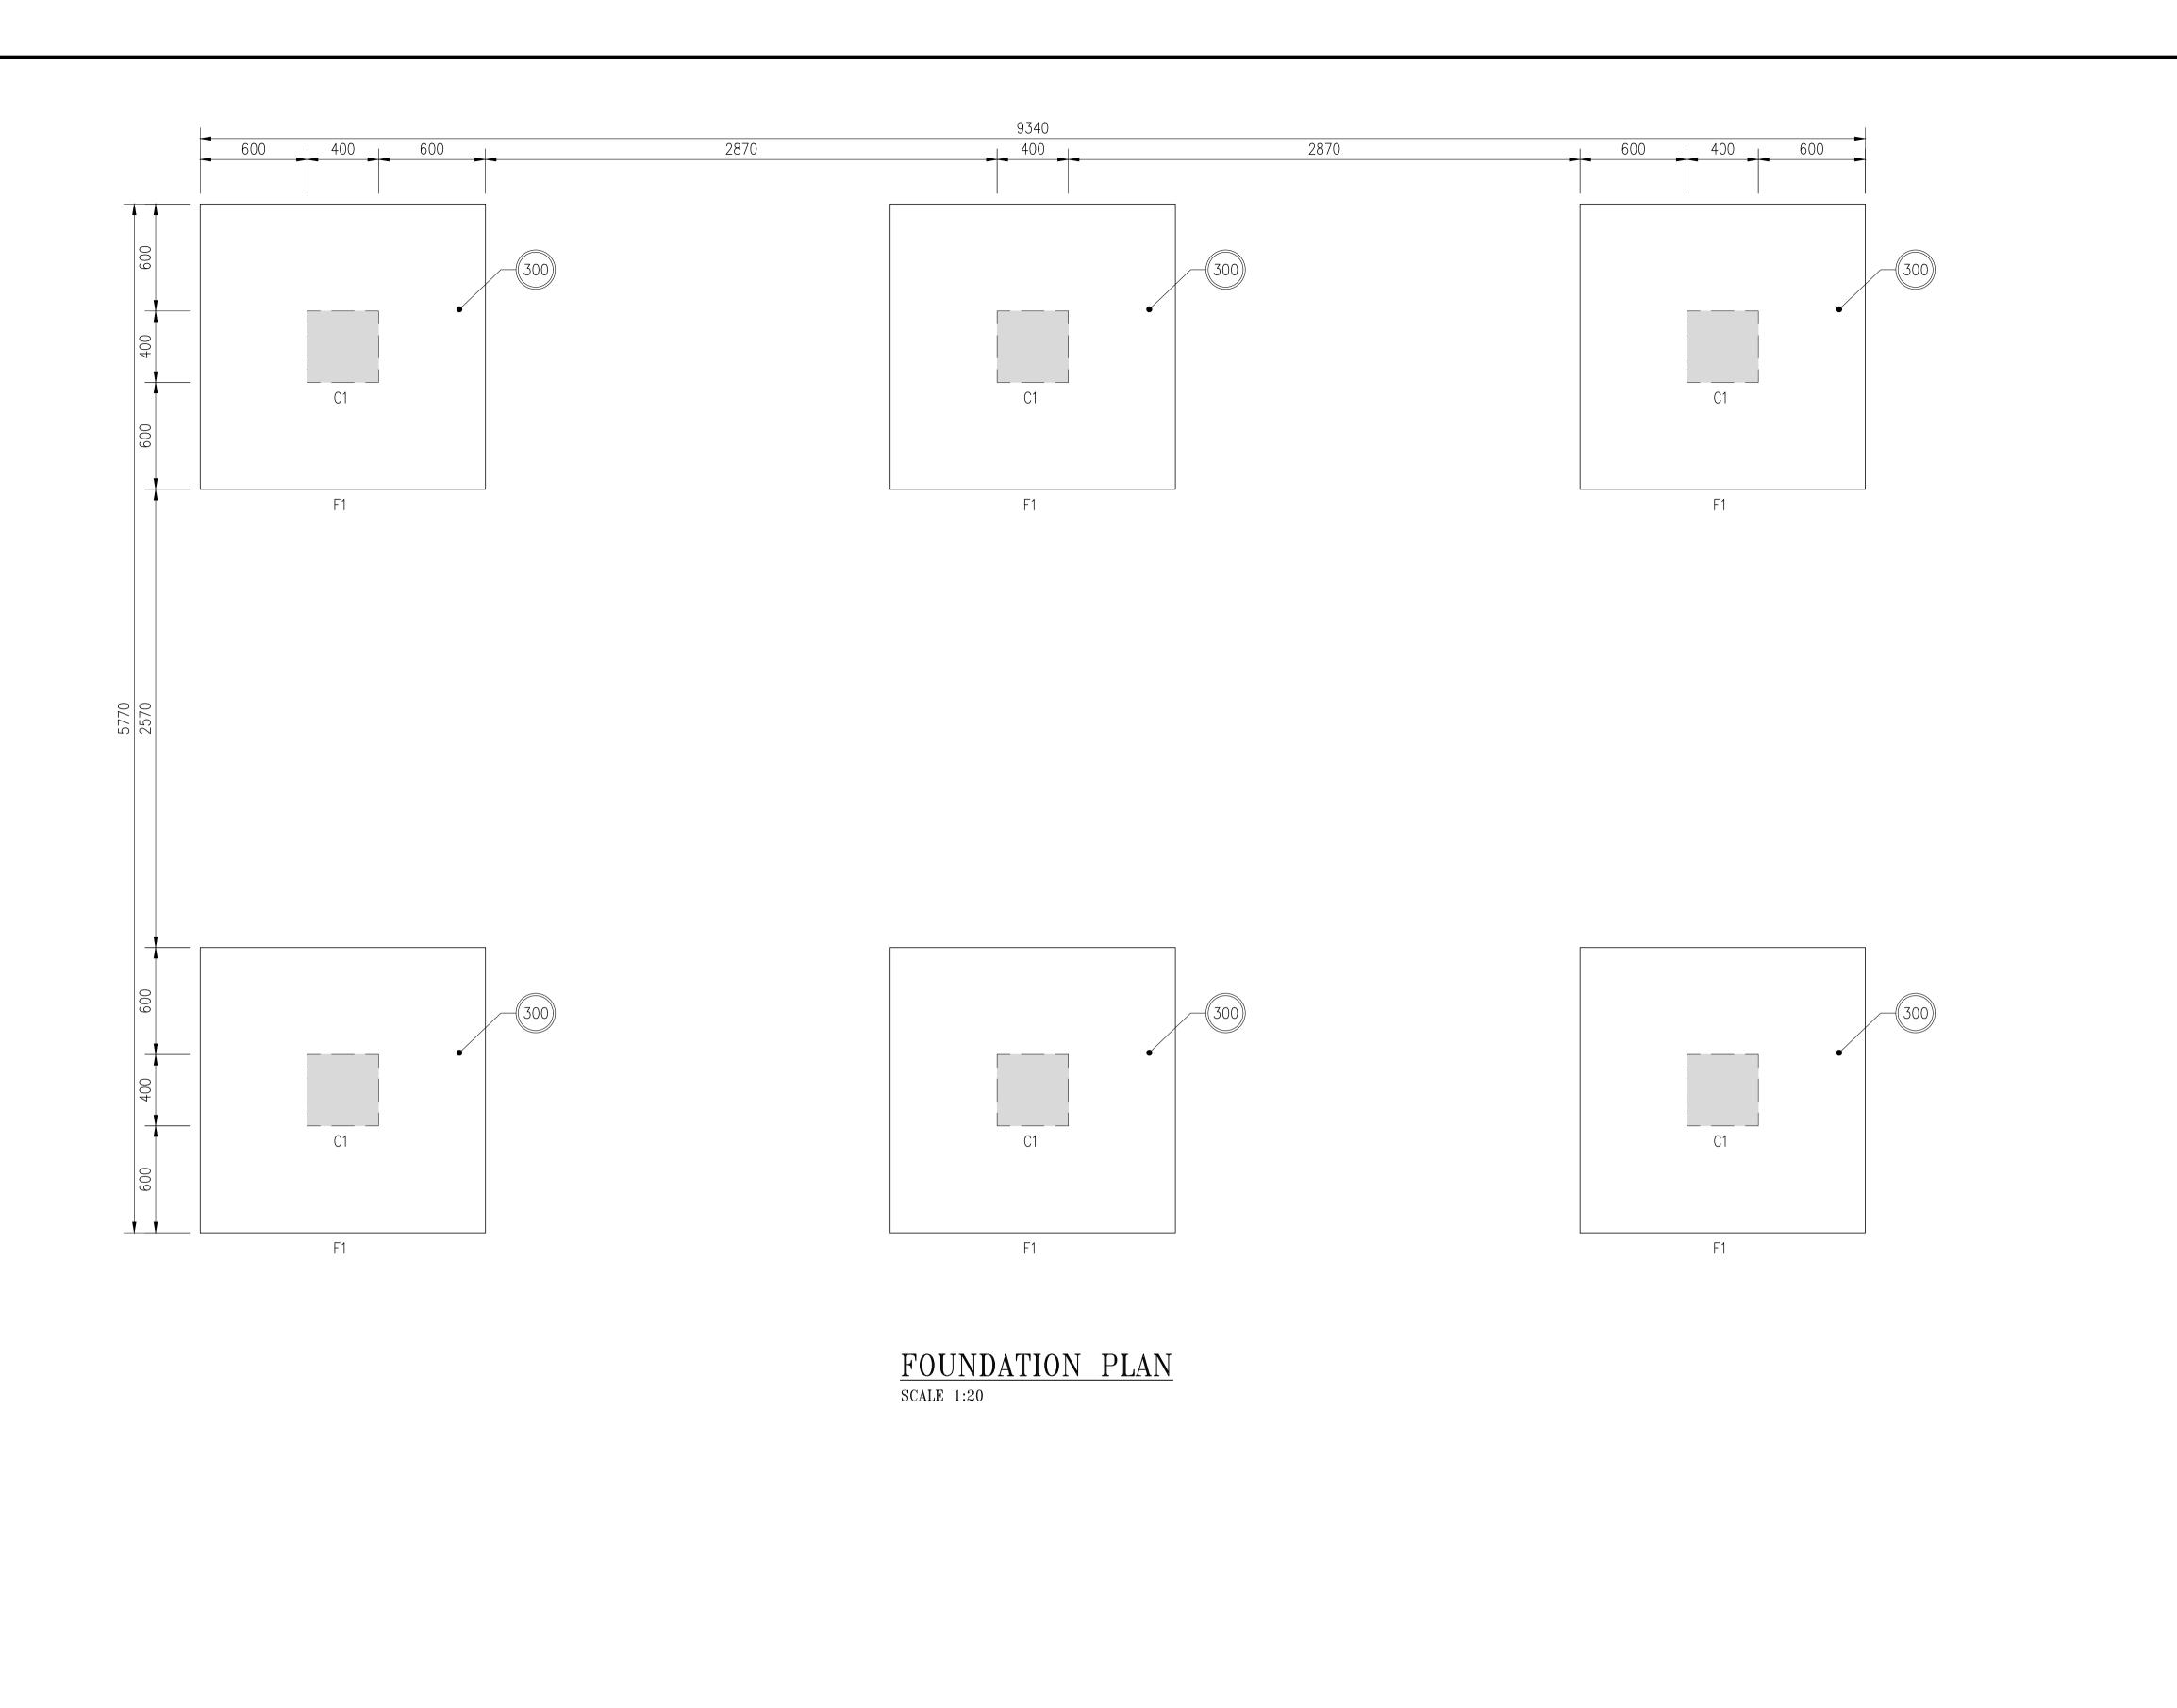

NOTE

- 1. ALL DIMENSION ARE IN MILLIMETERS UMLESS NOTED OTHERWISE.
- 2. ALL EXPOSED PIPELINE ARE TO BE POLYETHYLENE.
- 3. PIPEWORK TO CONNECTED WITH PE COMPRESSION FITTINGS UNLESS NOTED OTHERWISE.
- 4. ALL PE PIPE WORK AND FITTINGS TO BE CLASS PE100 SDR21 P8, UNLESS NOTED OTHERWISE.
- 5. PIPEWORK TO BE CONNECTED WITH APPROVED COMPRESSION FITTINGS.
- 6. ALL STEEL PIPE WORK AND FITTINGS TO BE 316 MARINE GRADE UNLESS NOTED OTHERWISE.
- 7. UNO, ALL CONCRETE TO HAVE A MINIMUM CHARACTERISTIC COMPRESSIVE STRENGTH (f'c) OF 30MPa AT 28 DAYS.
- 8. PLASTIC DAMP PROOF COURSE (DPC) SHEETING PROVIDED BETWEEN ALL CONCRETE AND SOIL INTERACTION.
- 9. THE MINIMUM BEARING CAPACITY OF THE SUB-BASE AT THE UNDERSIDE OF THE PAD FOOTING SHALL BE 150KPa. THE DEPTH OF THE PAD FOOTINGS MAY BE INCREASED TO ALLOW THE FOOTINGS TO BE FOUNDED ON A FIRMER STRATA.
- 10. APPROVED FILL MATERIAL TO BE COMPACTED IN LAYERS NOT EXCEEDING 200mm. 95% COMPACTION SHALL BE ACHIEVED.
- 11. BACKFILL MATERIAL SHALL BE SELECTED OR
  APPROVED AS SPECIFIED OR DIRECTED BY THE
  ENGINEER. SELECTED BACKFILL SHALL BE COARSE
  OR FINE. FINE SELECTED BACKFILL SHALL CONSIST OF
  FINE GRANULAR SOIL, OR LOAM, FREE OF HARD
  NODULES, ROOTS, STUMPS OR OTHER PIECES OF
  ORGANIC MATERIAL, AND CONTAINING NO STONES
  LARGER THAN 10mm. COARSE SELECTED BACKFILL
  SHALL CONSIST OF ANY WELL GRADED MATERIAL
  CONTAINING NO ROOTS, STUMPS OR OTHER PIECES
  OF ORGANIC MATERIAL, AND CONTAINING NO STONES
  LARGER THAN 75mm.

## <u>LEGEND:</u>

C1 — COLUMN F1 — PAD FOO

F1 — PAD FOOTING

(300) - FOOTING THICKNESS

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Client:	***	Pacific Community
	****	Communaut du Pacifique

18.10.23

CHECKED APPROVED DATE

0A FOR TENDER

DESCRIPTION



FAX: (679) 3302903 EMAIL: infor@nrwmacallan.com.fj

SUVA FIJI

HT	-		MANAGING COASTAL AQUIFERS (MCAP), V
necked: HS/NK	Date: 23.08.23	TITLE:	FOUNDATION
cale A1: AS SHOWN	Scale A3: HALF SHOWN		

FOUNDATION PLAN


REV. NO:

0A

BY NO:

DB. NO:

DB.

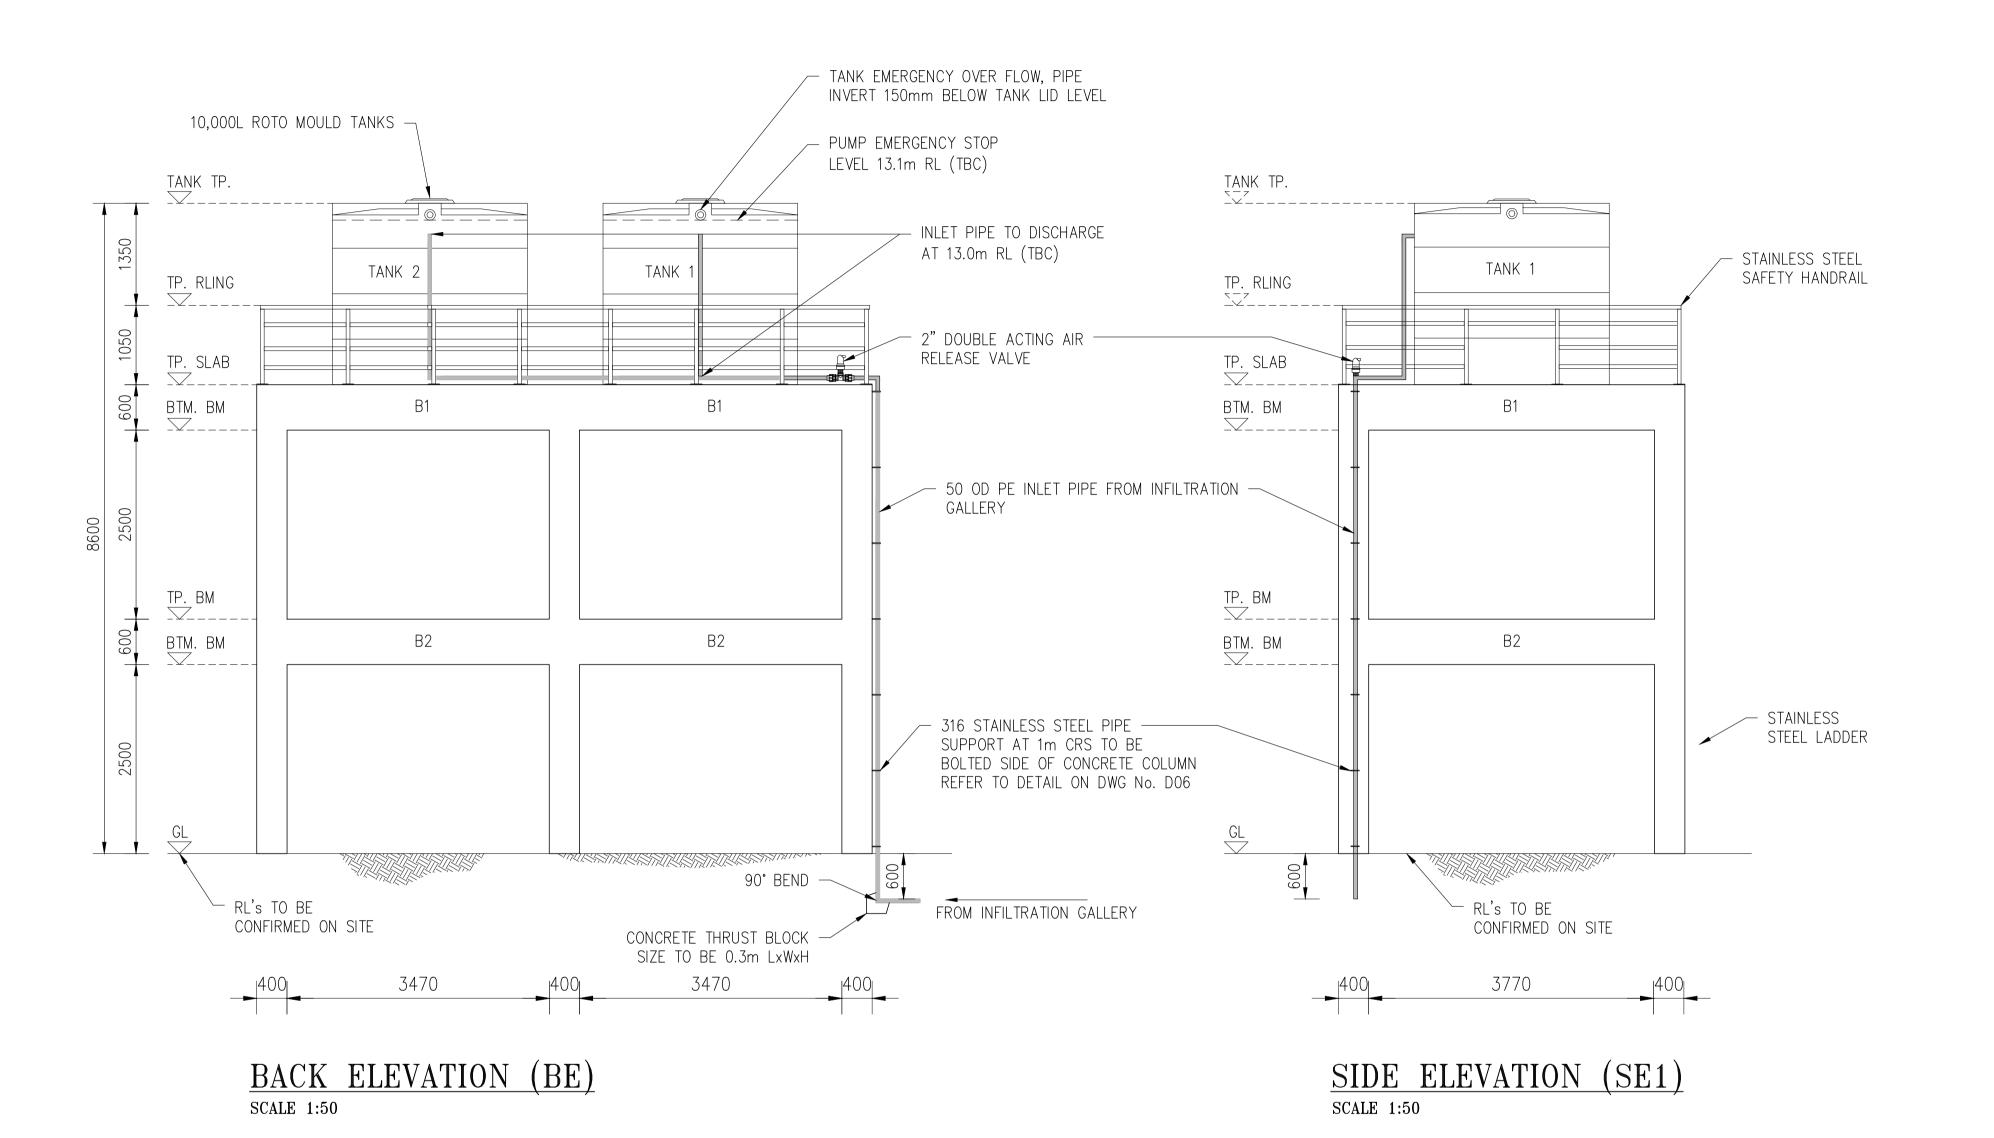

<u>NOTE:</u>

- 1. ALL DIMENSION ARE IN MILLIMETERS.
- 2. BUILDERS TO CHECK DIMENSION PRIOR TO CONSTRUCTION.
- 3. BUILDER NOT TO MAKE ANY CHANGES, IF DO SO, NOTIFY APPROVAL OF THE ENGINEER OR SUPERVISOR ON SITE.
- 4. CONCRETE IS TO BE 30MPa STRENGTH.
- 5. ALL PE PIPE WORK AND FITTINGS TO BE CLASS PE100 SDR21 P8, UNLESS NOTED OTHERWISE.
- 6. ALL STEEL PIPE WORK AND FITTINGS TO BE 316 STAINLESS STEEL GRADE.
- 7. ALL EXPOSED PIPELINE ARE TO BE POLYETHYLENE.
- 8. FINAL PIPE WORK LEVELS TO BE CONFIRMED ON SITE PRIOR TO CONSTRUCTION.

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	Client:	***	Pacific Community
18.10.23		***	Communauté
		***	du Pacifique

CHECKED APPROVED DATE

0A FOR TENDER

DESCRIPTION



FAX: (679) 3302903


EMAIL: infor@nrwmacallan.com.fj

SUVA FIJI

Dianer.	Designed.	1100001.
HT	-	MANAGING COASTAL AQUIFERS (MCAP), WOTJE, MARSHALL ISLAND
Checked: HS/NK	Date: 23.08.23	TITLE: HEADER TANK
		INLET PIPE WORK
Scale A1:	Scale A3:	11122111121111
AS SHOWN	HALF SHOWN	ELEVATION (BE & SE1)
		<del>-</del>

JOB. NO:

REV. NO:

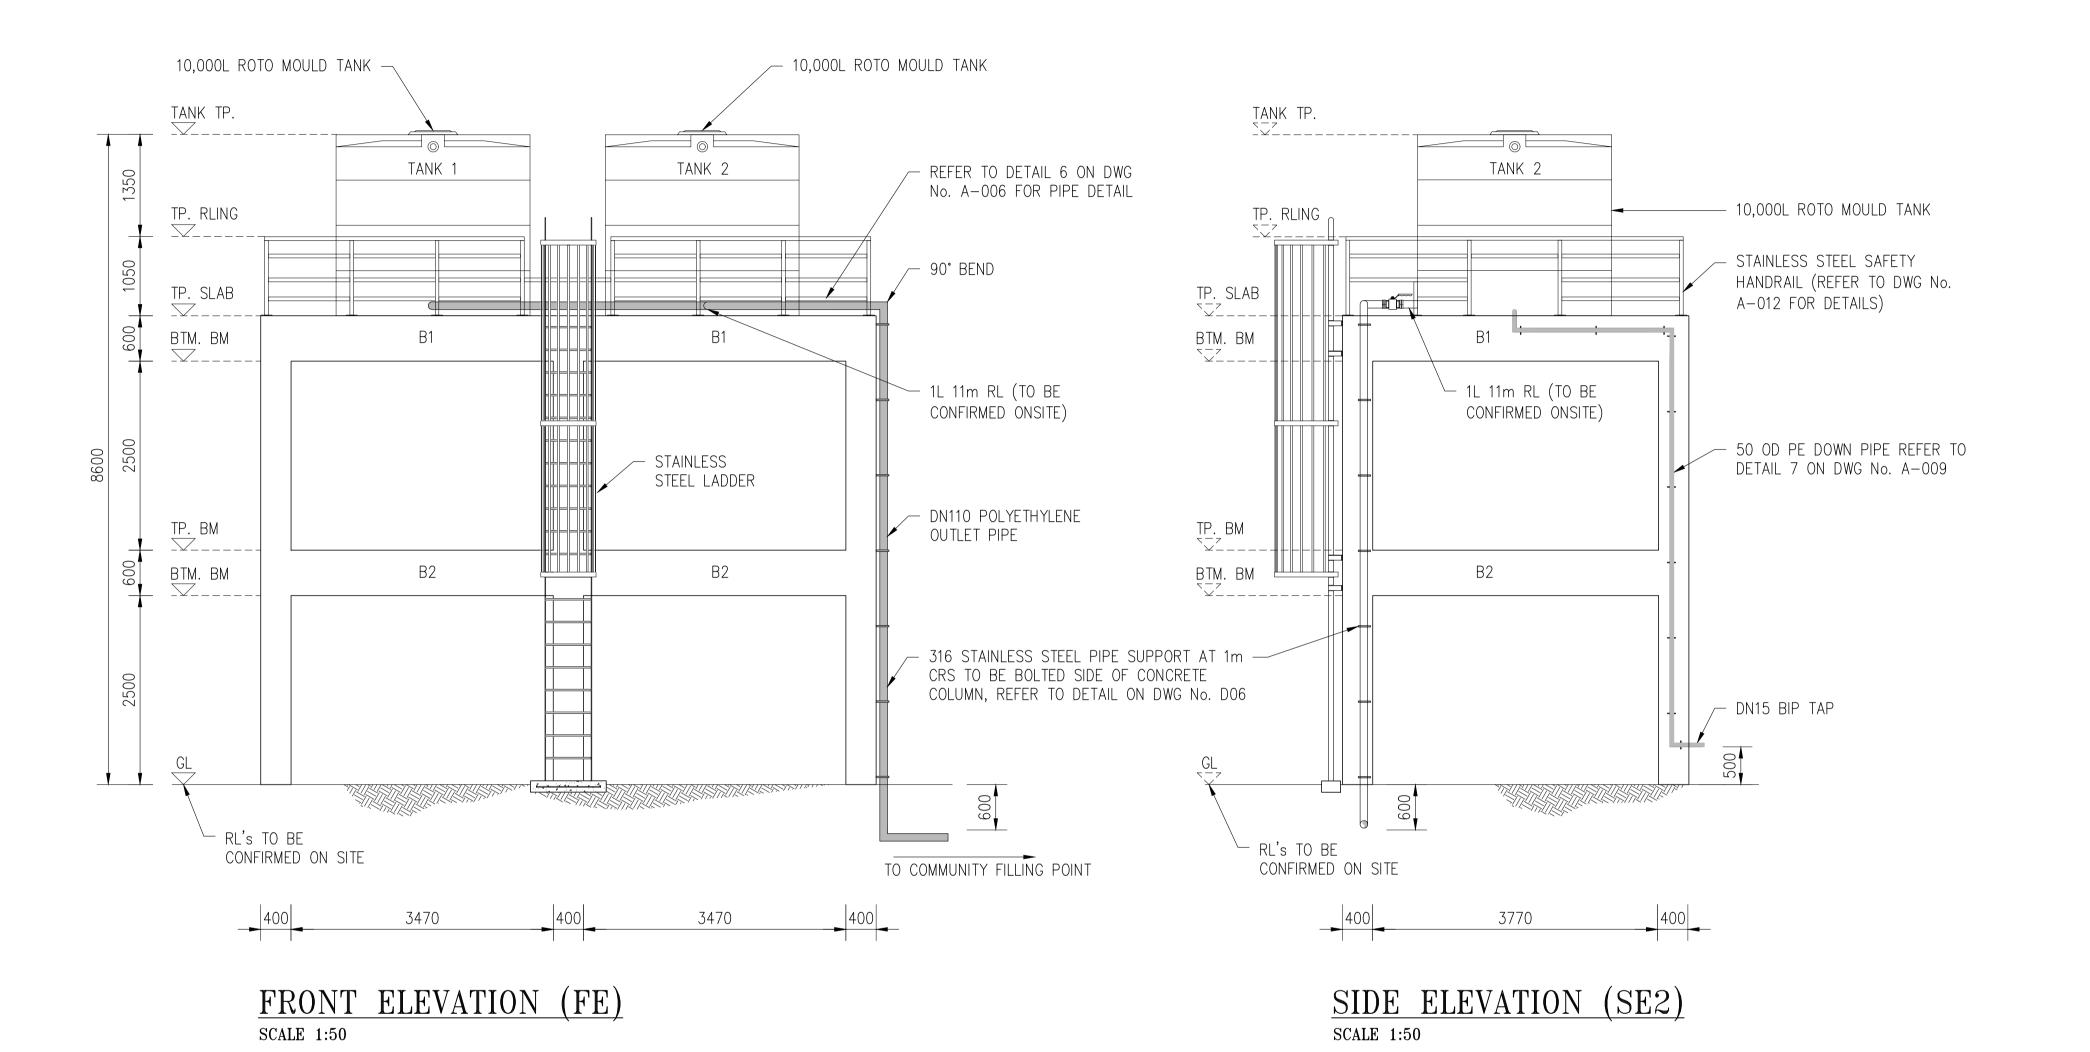

NOTE:

- 1. ALL DIMENSION ARE IN MILLIMETERS.
- 2. BUILDERS TO CHECK DIMENSION PRIOR TO CONSTRUCTION.
- 3. BUILDER NOT TO MAKE ANY CHANGES, IF DO SO, NOTIFY APPROVAL OF THE ENGINEER OR SUPERVISOR ON SITE.
- 4. ALL PE PIPE WORK AND FITTINGS TO BE CLASS PE100 SDR21 P8, UNLESS NOTED OTHERWISE.
- 5. ALL STEEL PIPE WORK AND FITTINGS TO BE 316 STAINLESS STEEL GRADE.
- 6. ALL PVC PIPE WORK FITTINGS TO BE SN8 RRJ UNLESS NOTED OTHERWISE.
- 7. FINAL PIPE WORK LEVELS TO BE CONFIRMED ON SITE PRIOR TO CONSTRUCTION.
- 8. TANK DESIGN TO BE COMPLETED BY OTHERS. INSTALLATION OF TANK TO BE AS PER MANUFACTURER SPECIFICATION.

18.10.23

CHECKED APPROVED DATE

0A FOR TENDER

**DESCRIPTION** 

Pacific Community
Communauté du Pacifique



SUVA FIJI TING ENGINEERS

Checked: Date:

HS/NK 23.08.23

TELEPHONE: (679) 3313388

MOBILE: (679)

FAX: (679) 3302903

EMAIL: infor@nrwmacallan.com.fj

AS SHOWN

HALF SHOWN

Designed:

HEADER TANK
INLET PIPE WORK
ELEVATION (FE & SE2)

JOB. NO:

22307117

REV. NO: DRAWING. NO:


DRAWING. NO:
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NOTE:

- 1. ALL DIMENSION ARE IN MILLIMETERS UMLESS NOTED OTHERWISE.
- 2. FINAL PIPE WORK LEVEL TO BE CONFIRMED ON SITE PRIOR TO CONSTRUCTION.
- 3. ALL EXPOSED PIPELINE ARE TO BE POLYETHYLENE.
- 4. PIPEWORK TO CONNECTED WITH PE COMPRESSION FITTINGS UNLESS NOTED OTHERWISE.
- 5. ALL PE PIPE WORK AND FITTINGS TO BE CLASS PE100 SDR21 P8, UNLESS NOTED OTHERWISE.
- 6. PIPEWORK TO BE CONNECTED WITH APPROVED COMPRESSION FITTINGS.
- 7. ALL STEEL PIPE WORK AND FITTINGS TO BE 316 MARINE GRADE UNLESS NOTED OTHERWISE.

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Designed: MANAGING COASTAL AQUIFERS (MCAP), WOTJE, MARSHALL ISLAND HT Checked: TITLE: GALLERY TANK SECTION Date: 23.08.23 HS/NK

Scale A3:

HALF SHOWN

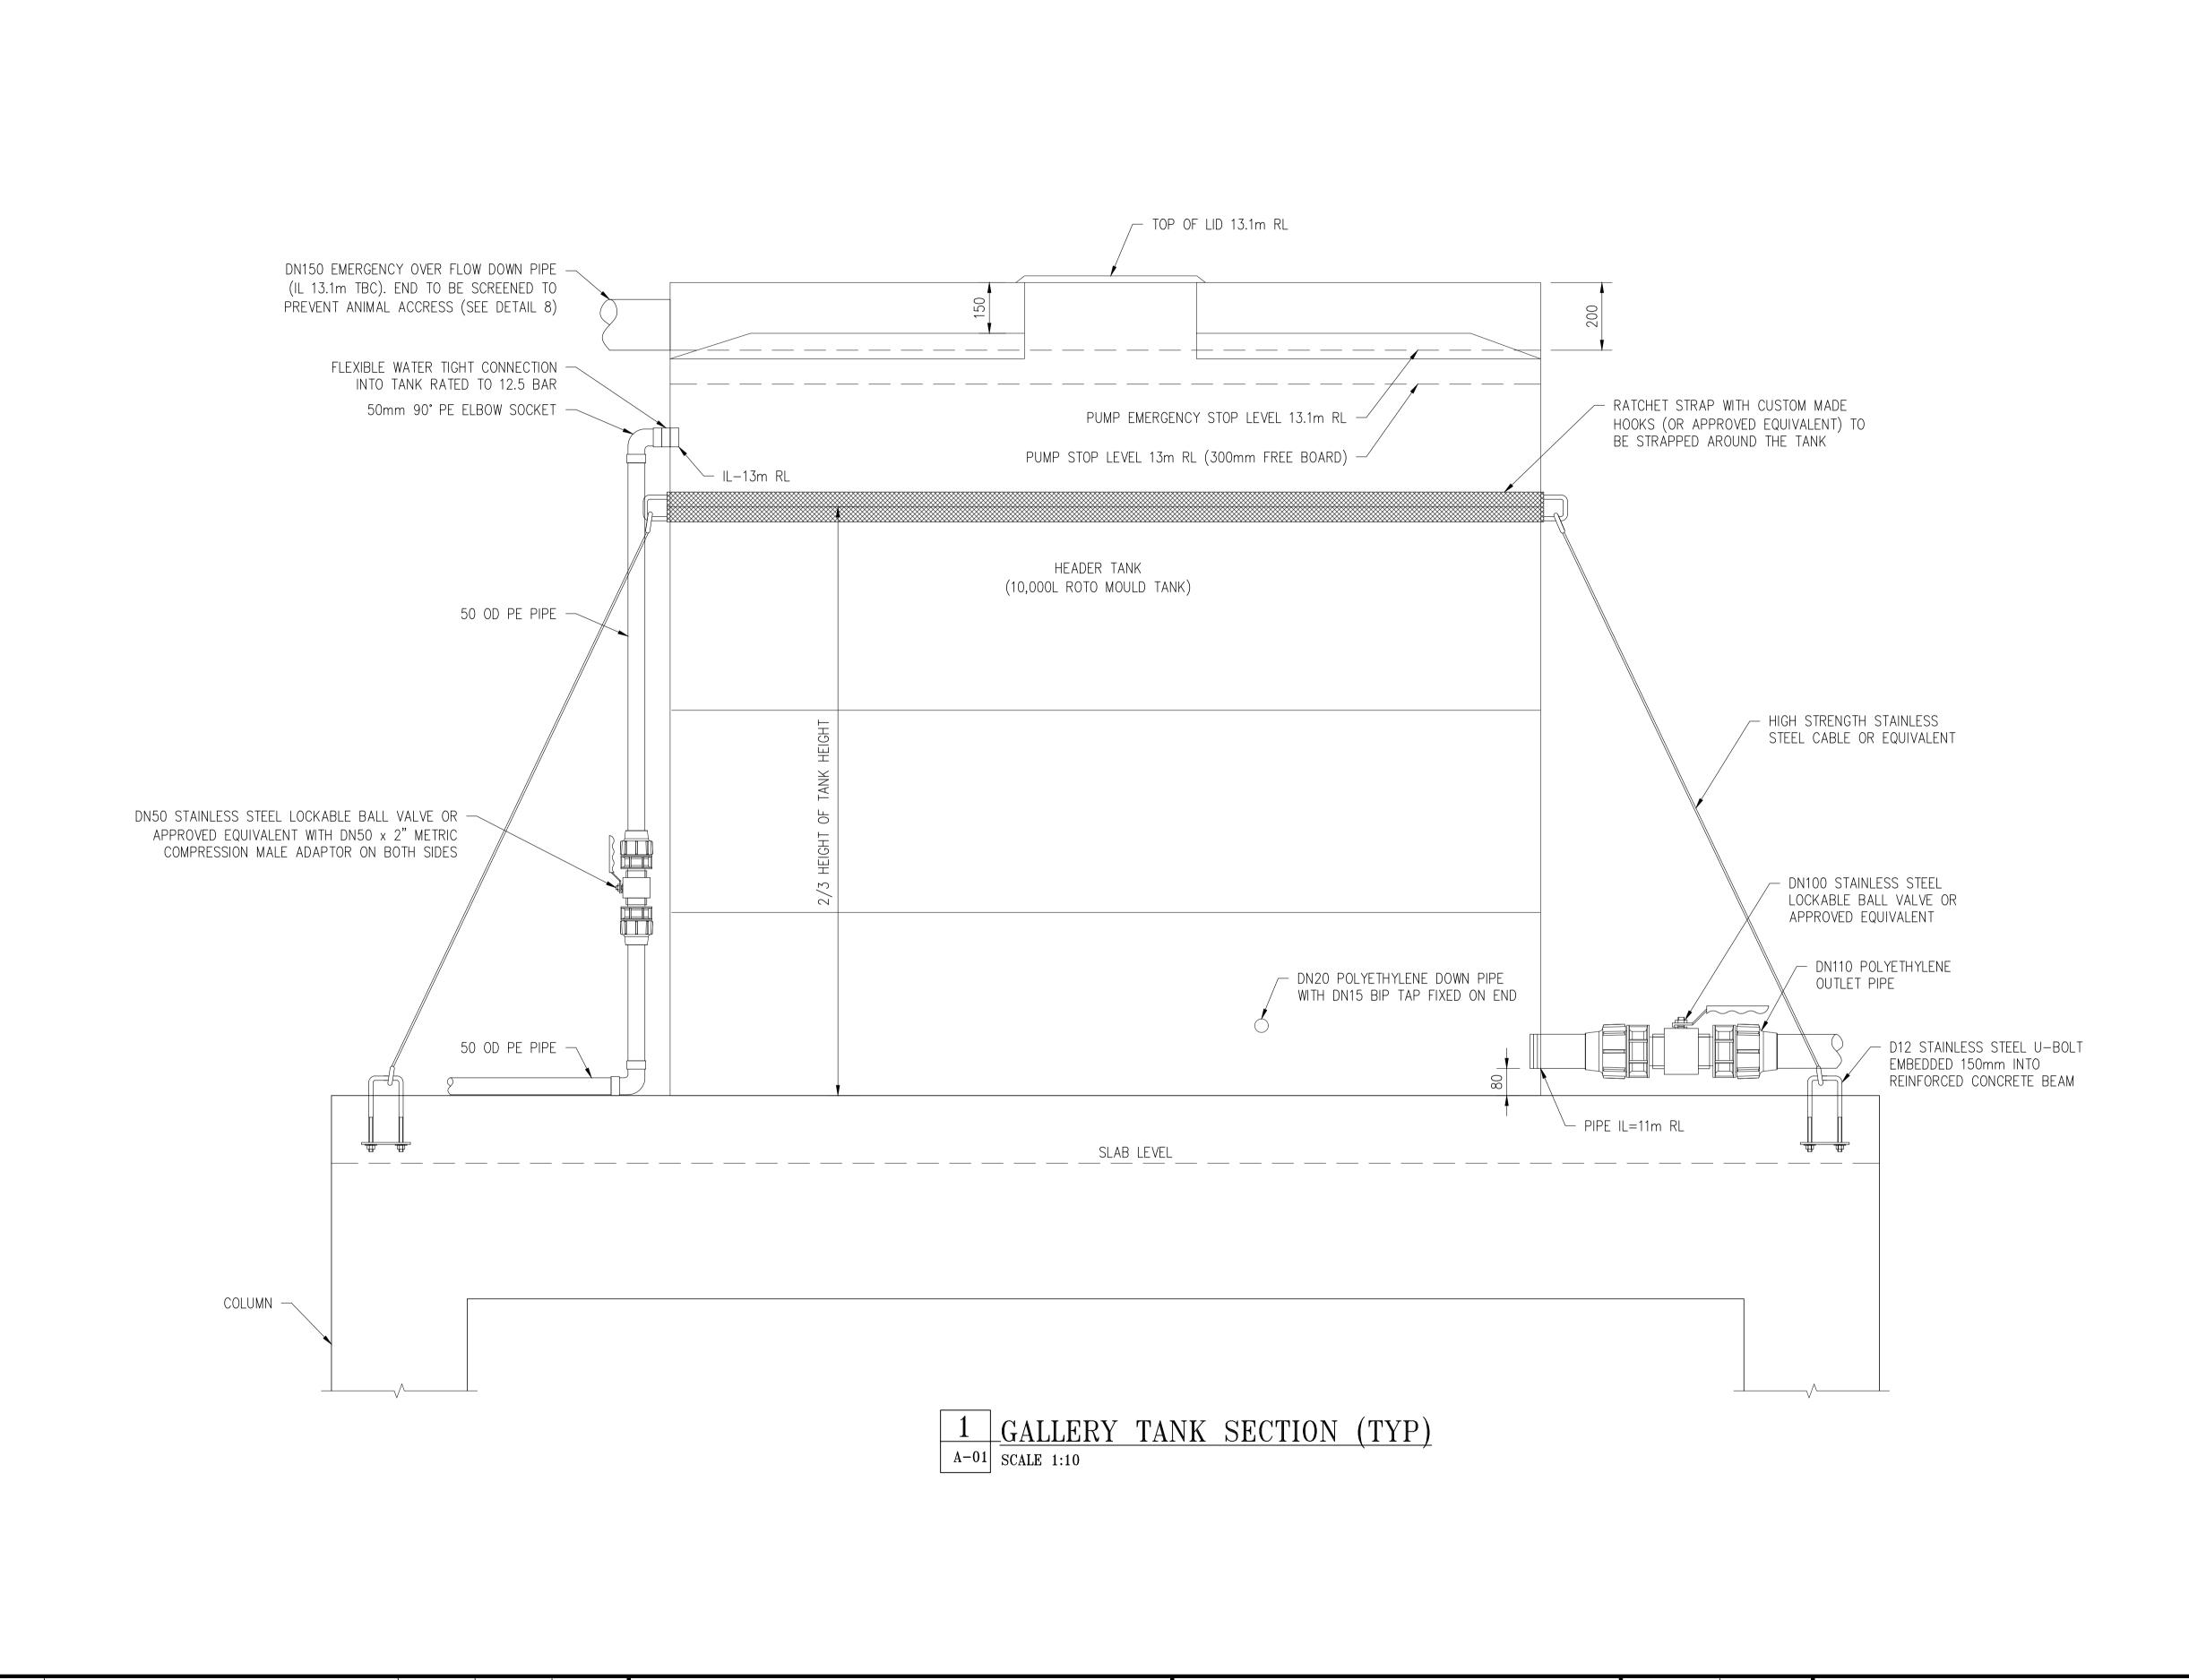Scale A1:

AS SHOWN

22307117

JOB. NO:

DRAWING. NO: A-005


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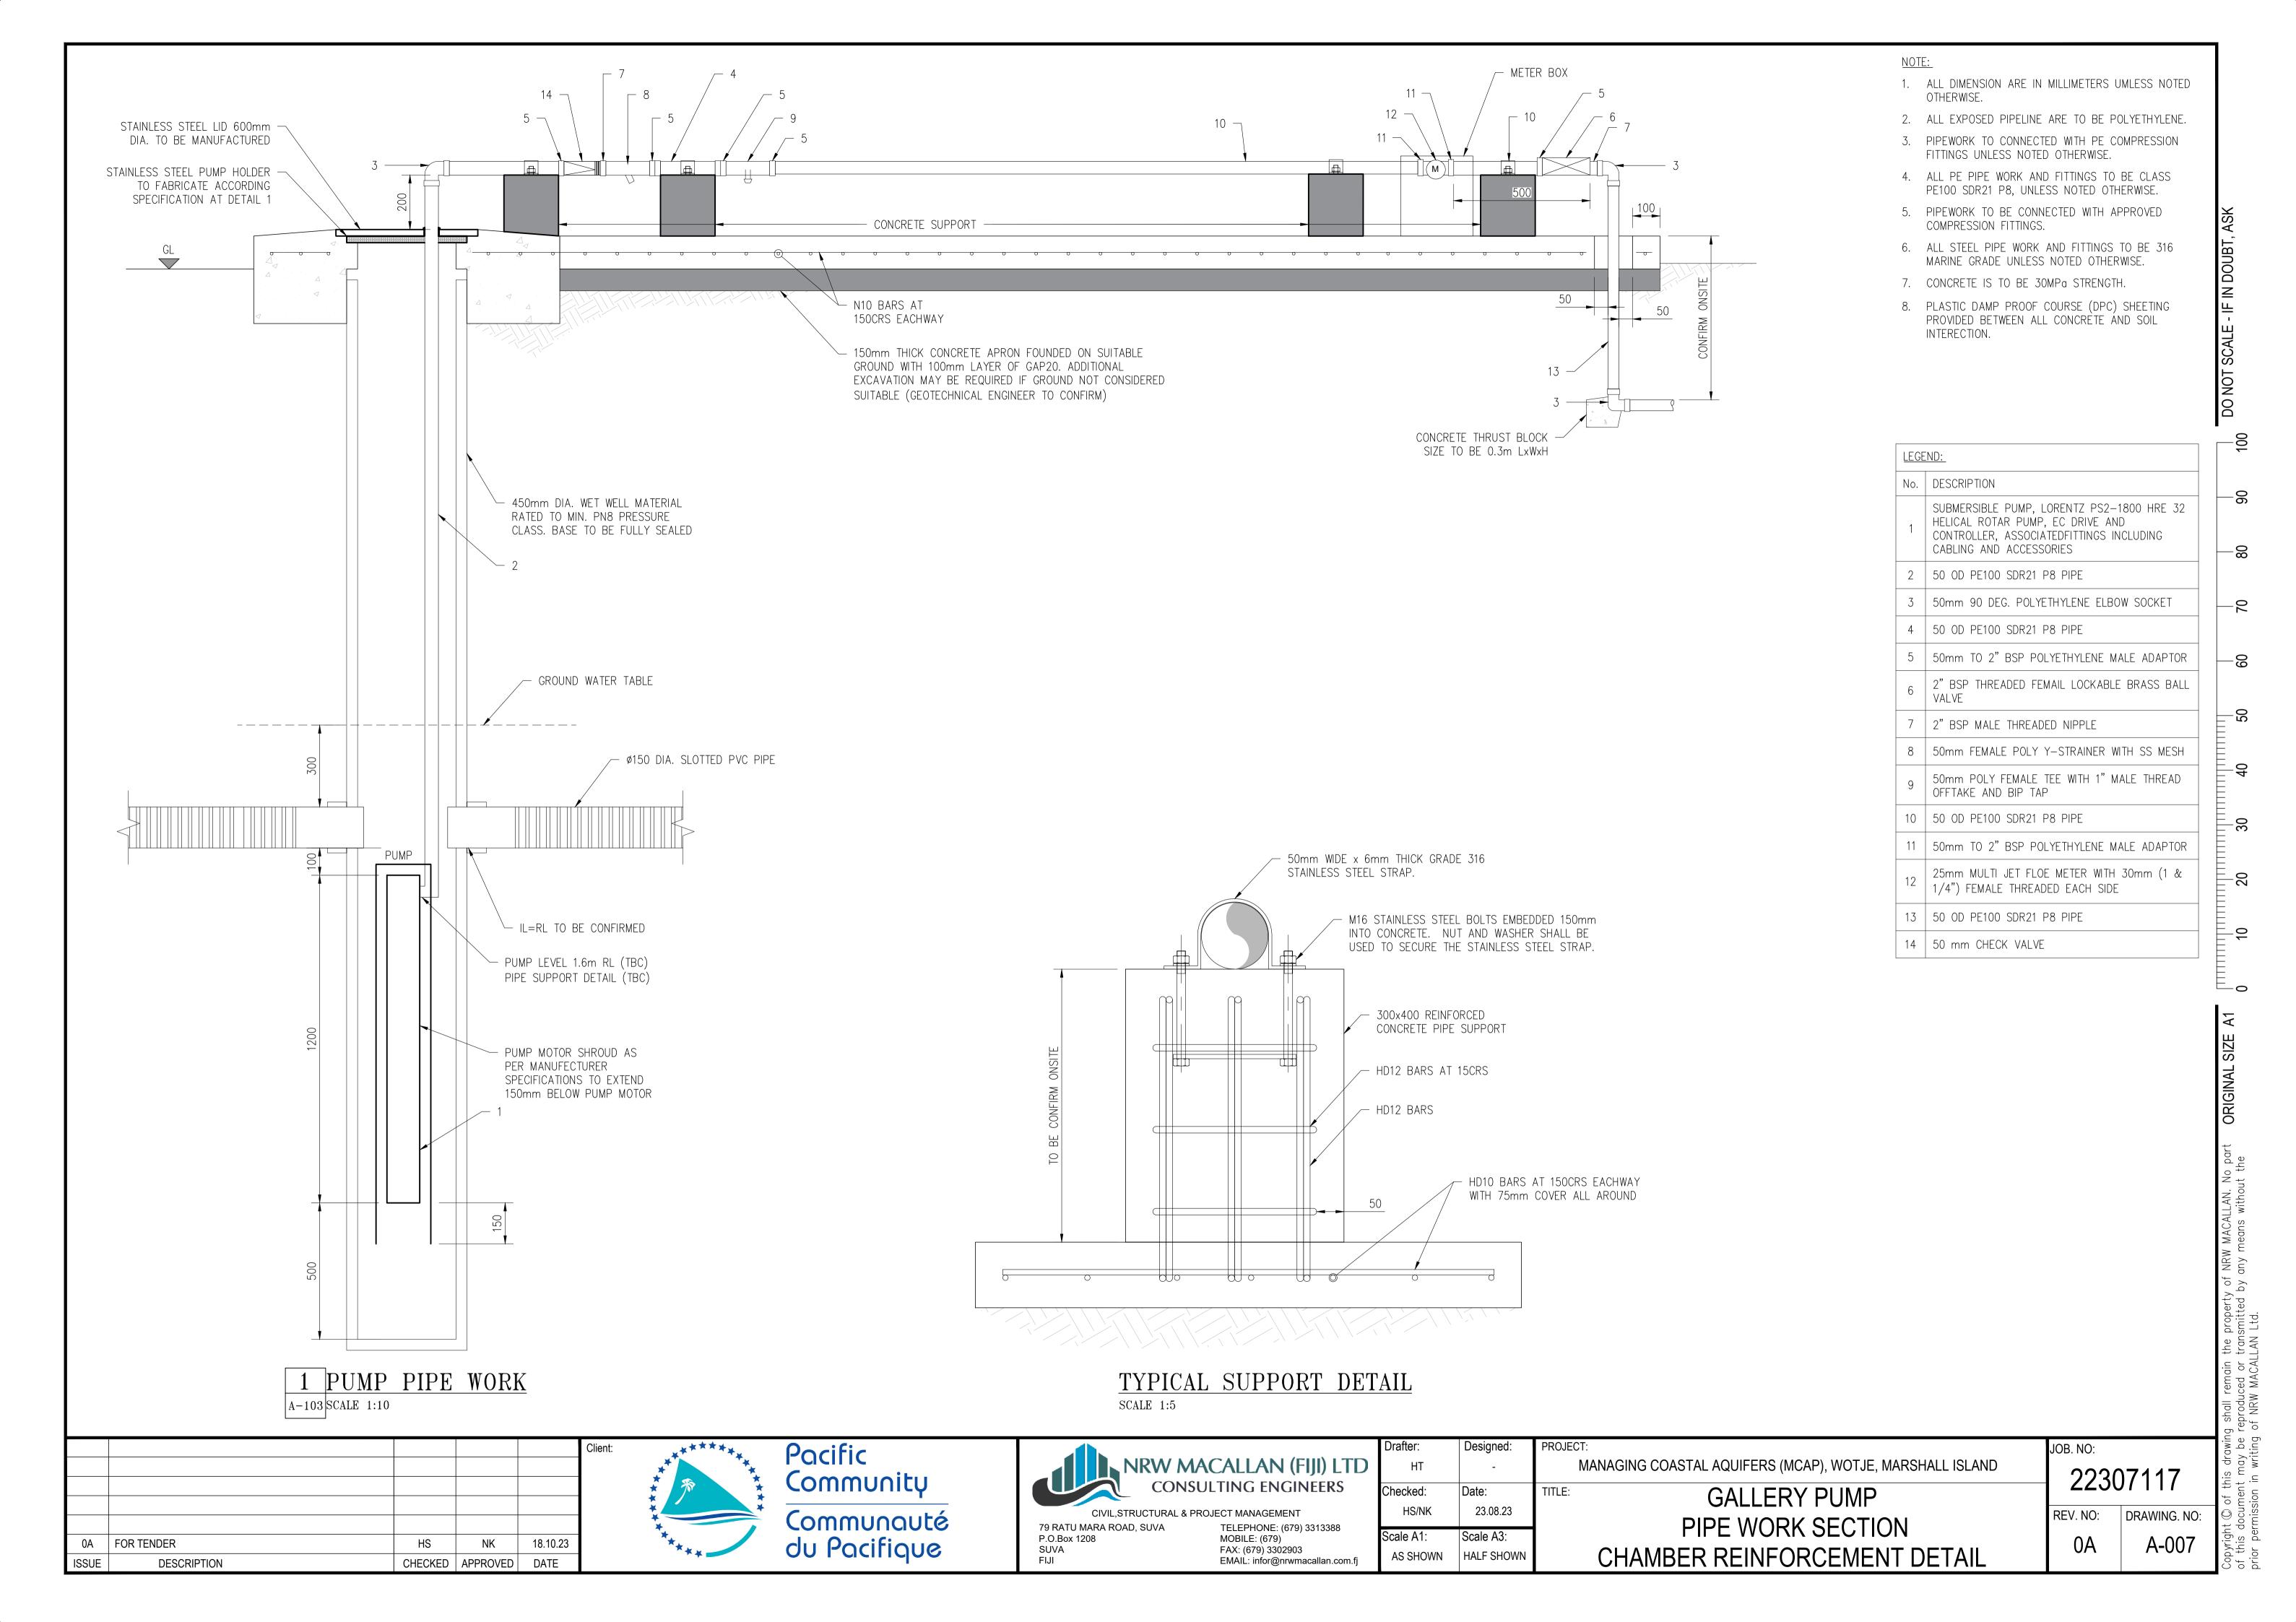
Pacific Community Communauté du Pacifique


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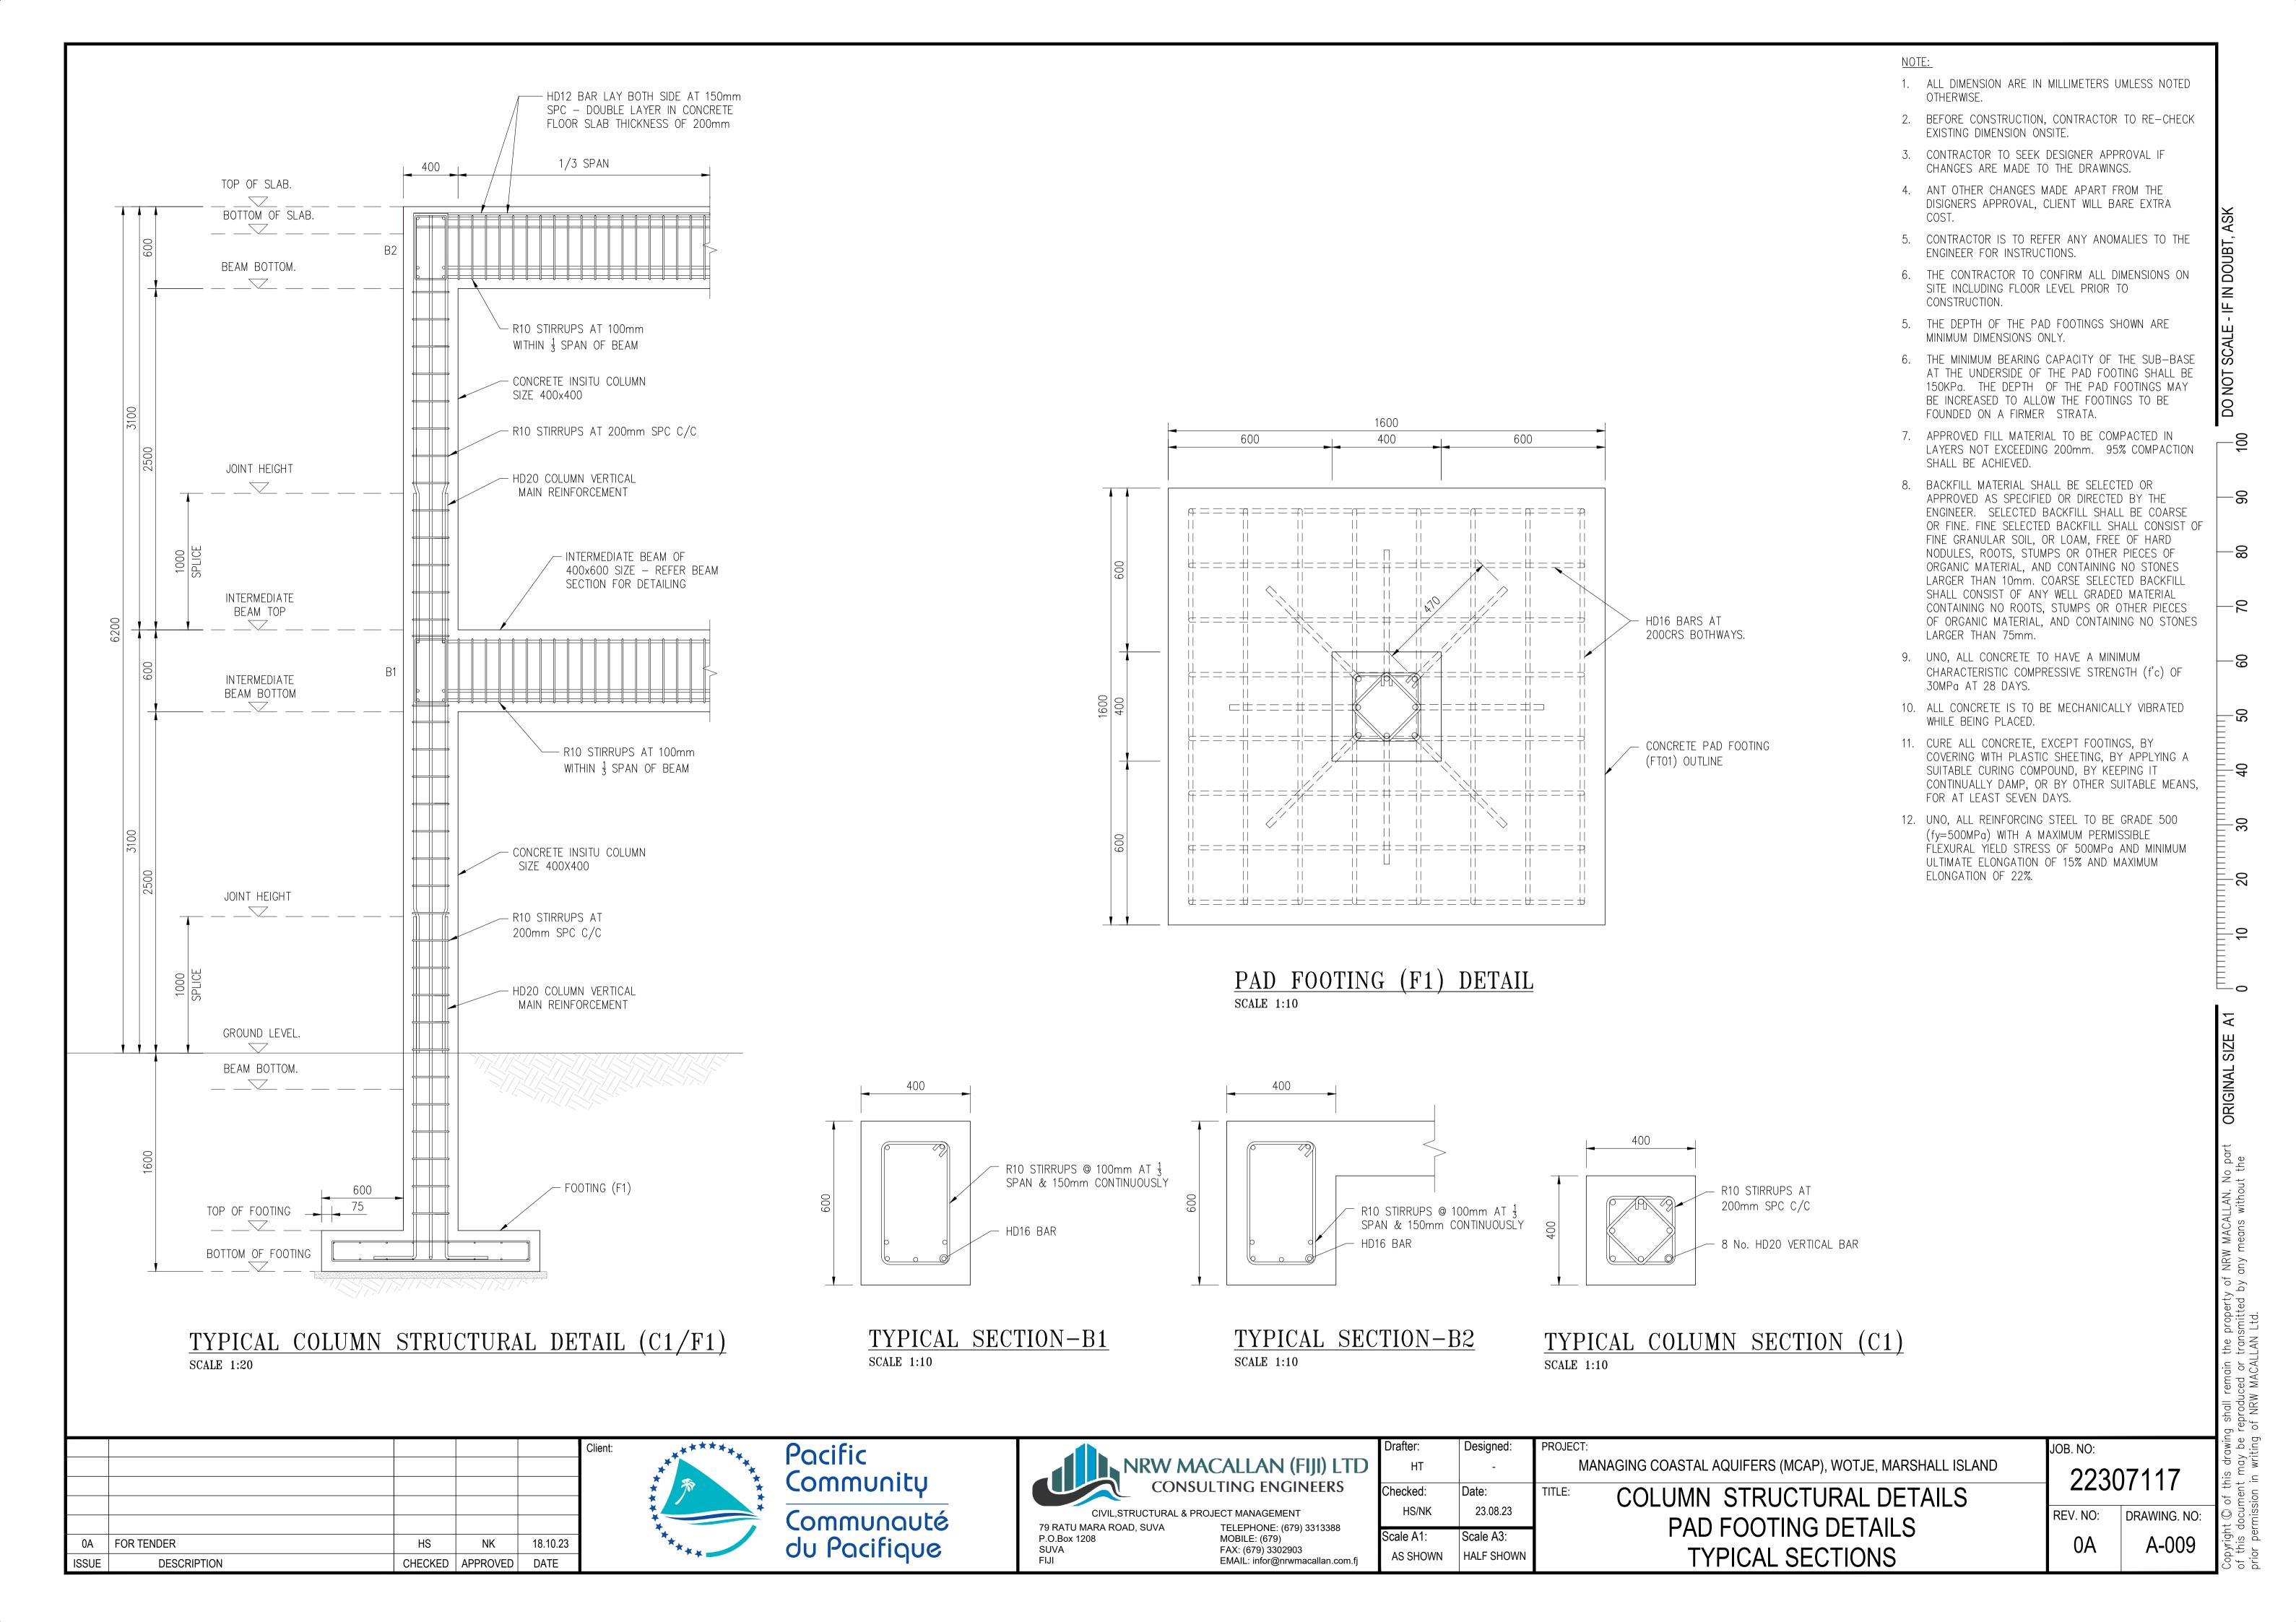
**CONSULTING ENGINEERS** CIVIL,STRUCTURAL & PROJECT MANAGEMENT TELEPHONE: (679) 3313388 MOBILE: (679) 79 RATU MARA ROAD, SUVA P.O.Box 1208 SUVA FIJI FAX: (679) 3302903 EMAIL: infor@nrwmacallan.com.fj


NRW MACALLAN (FIJI) LTD







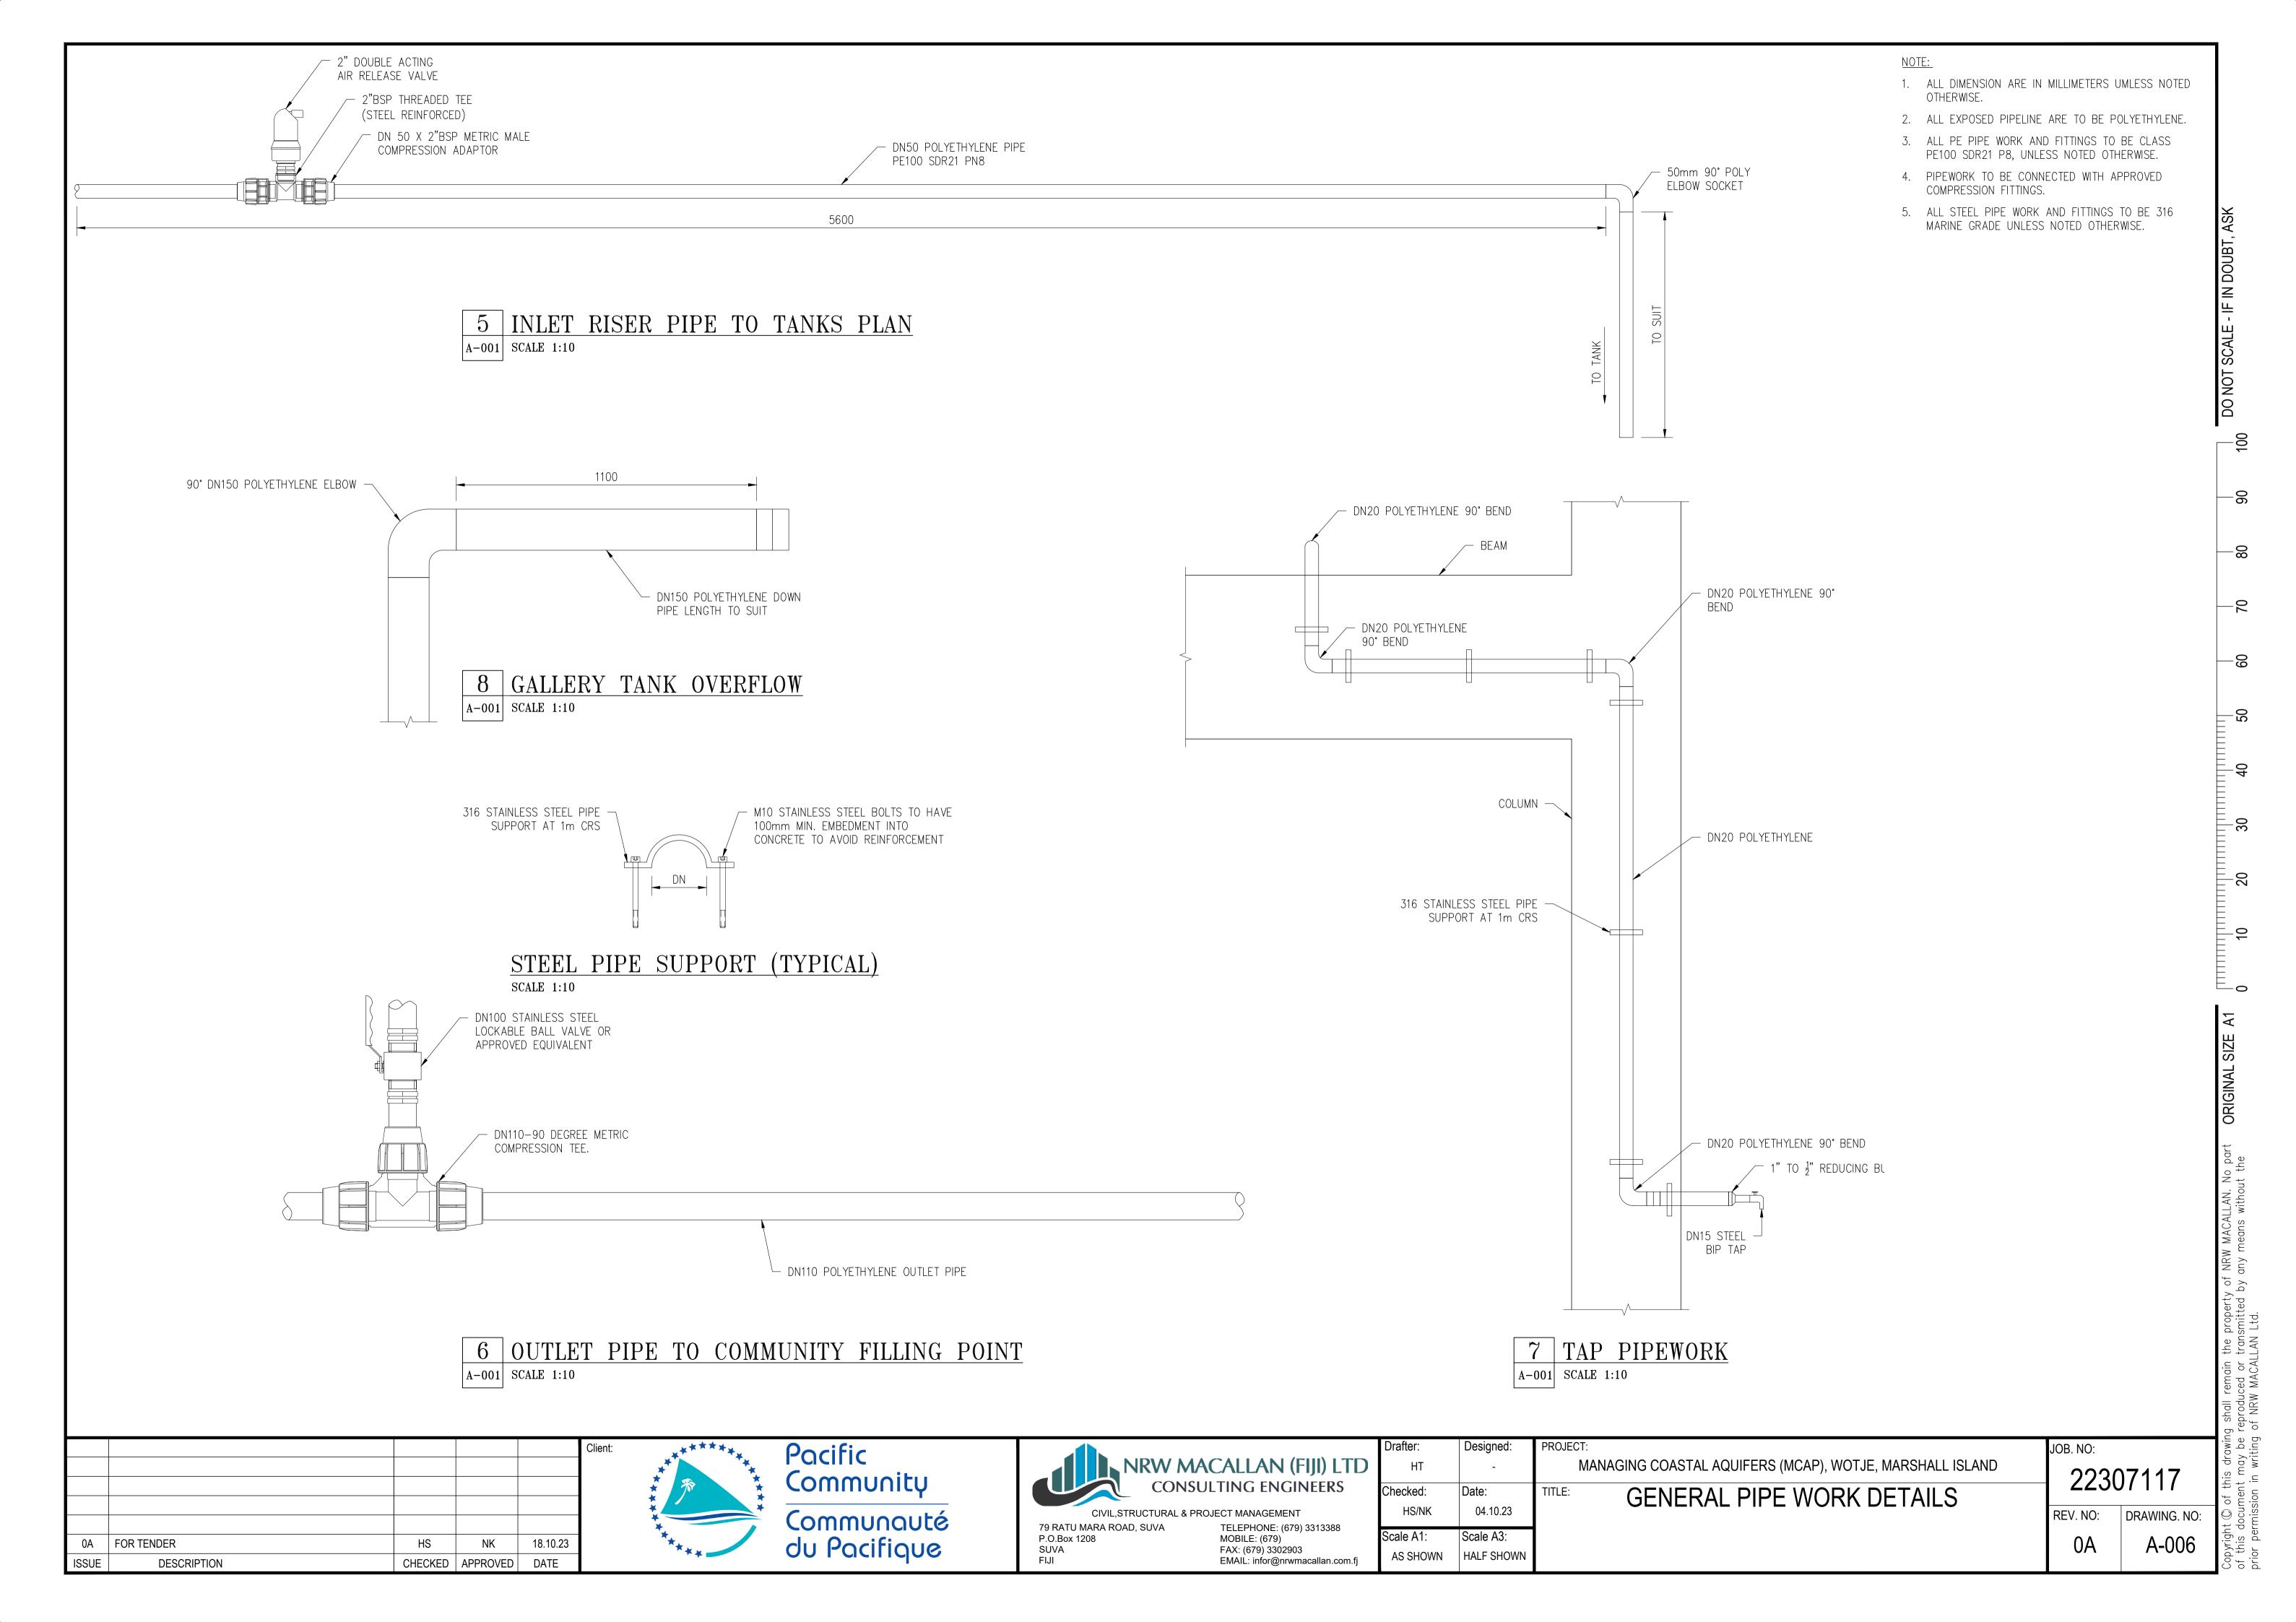

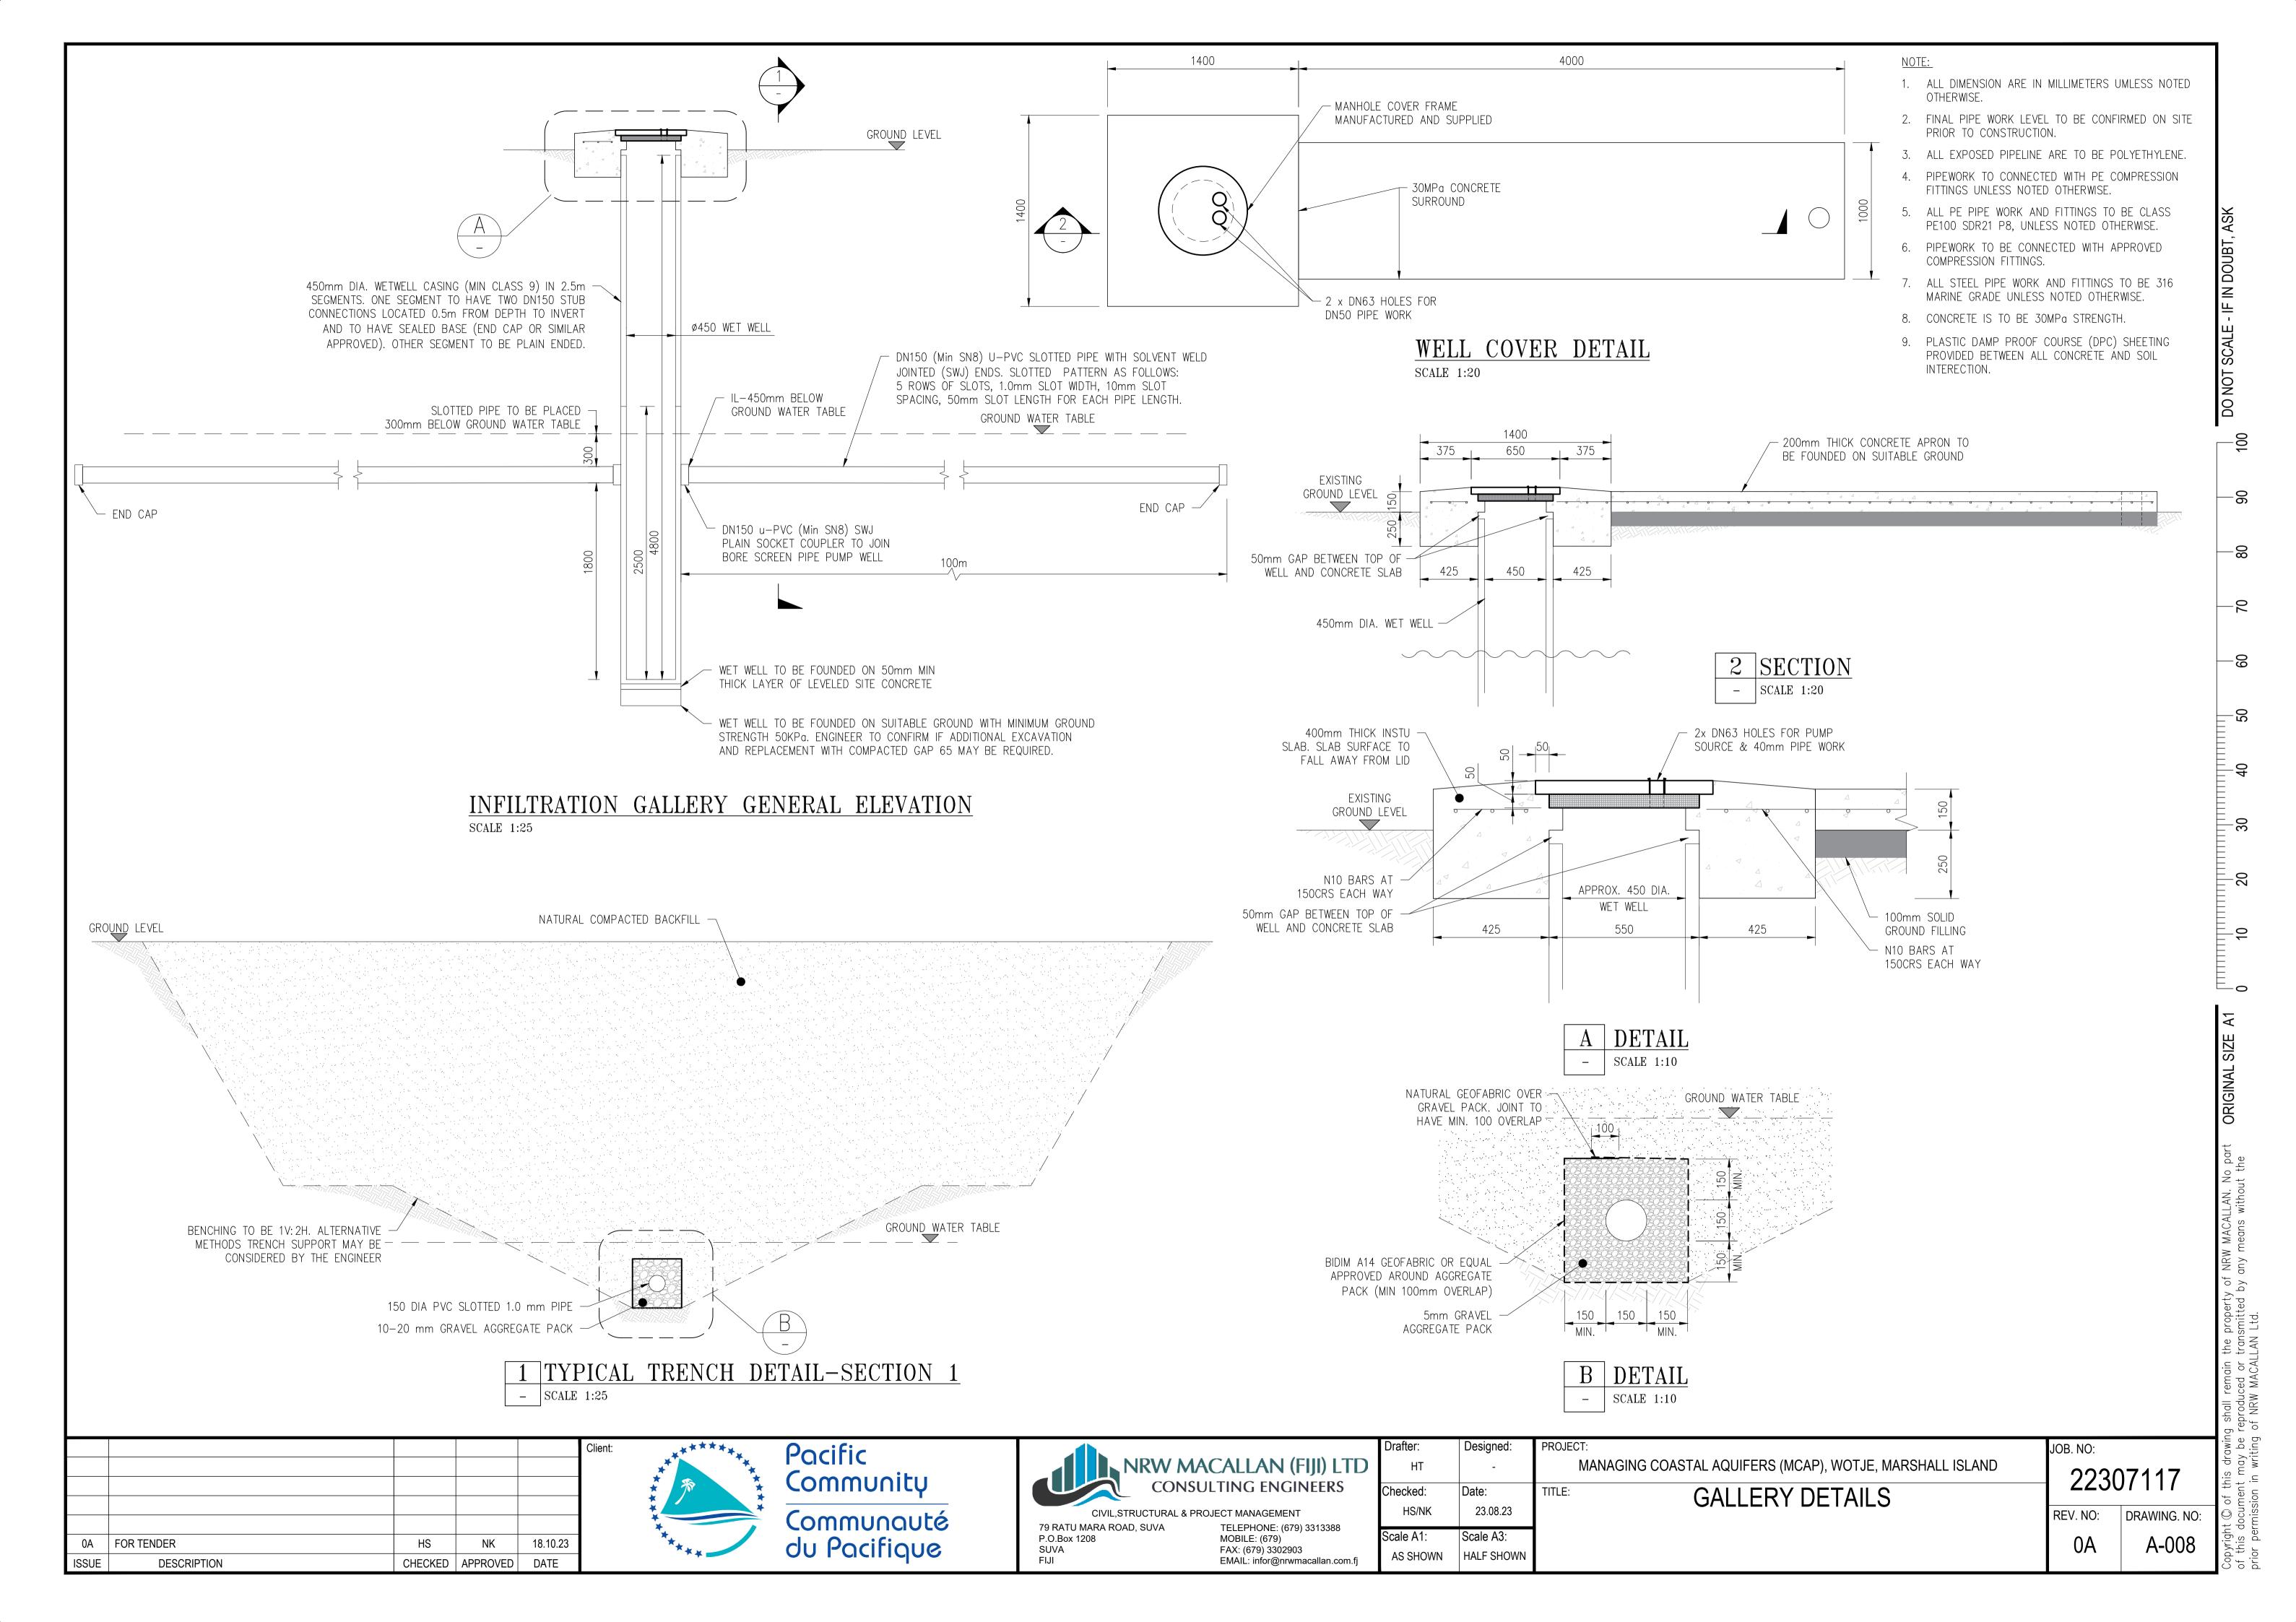

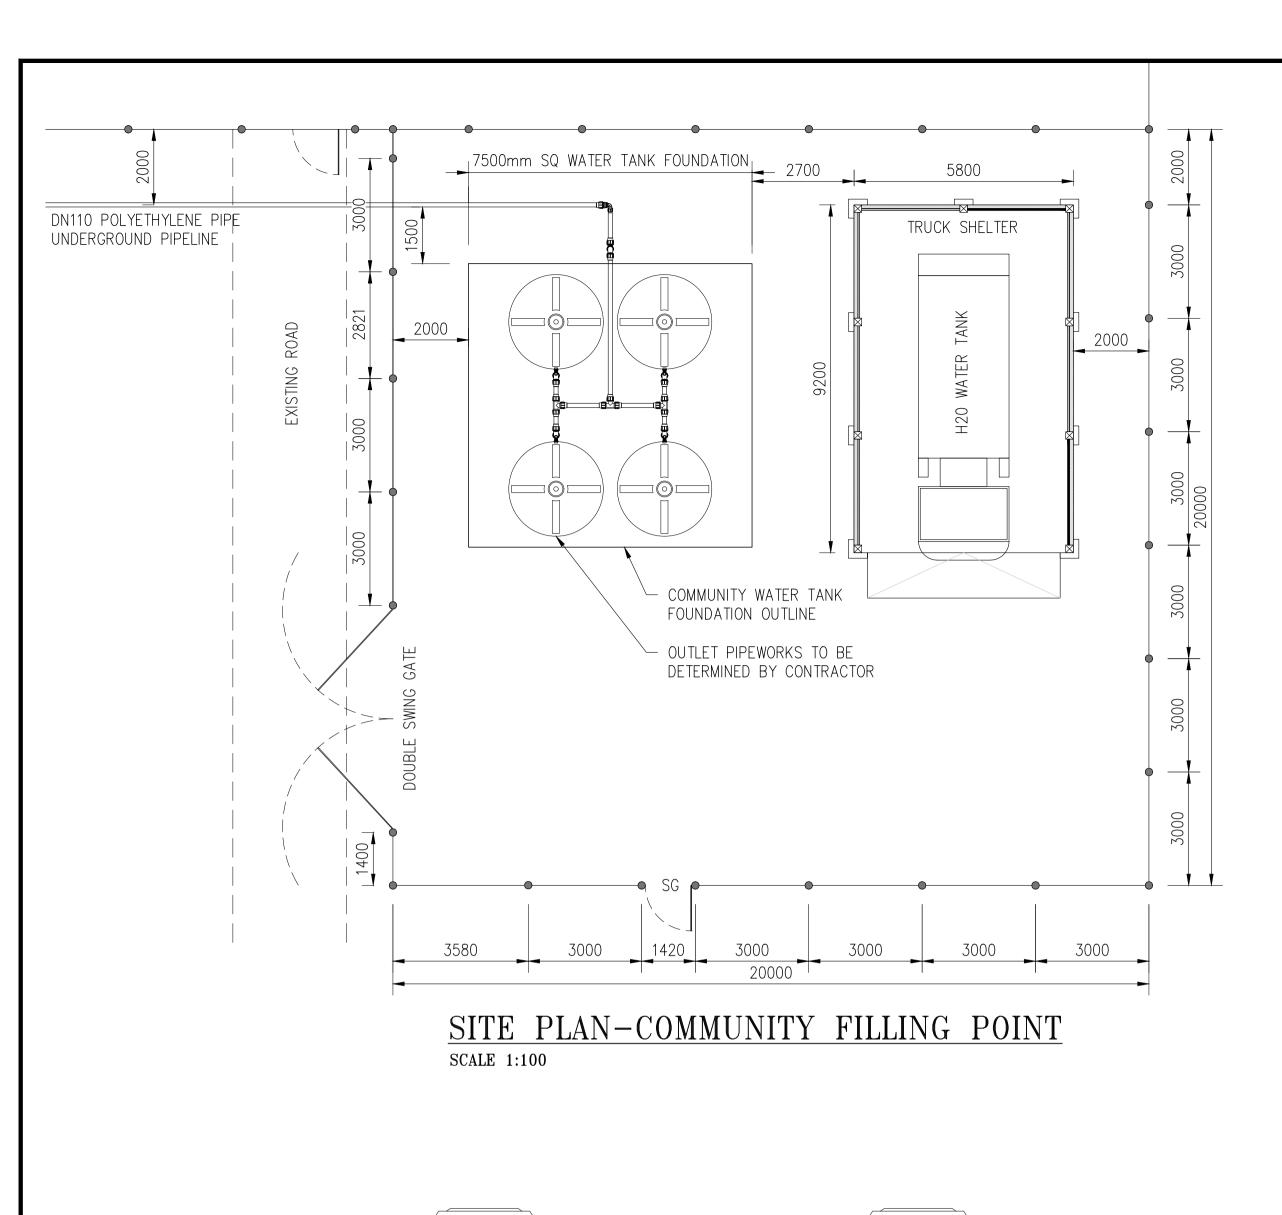

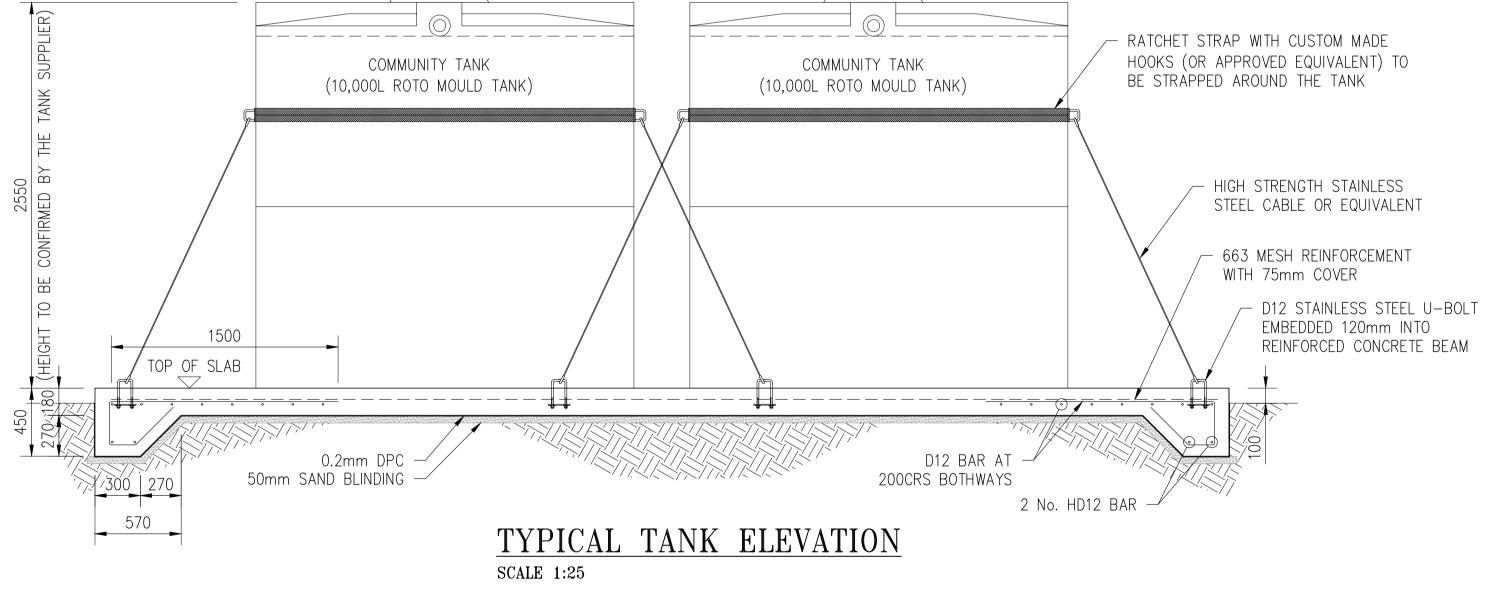

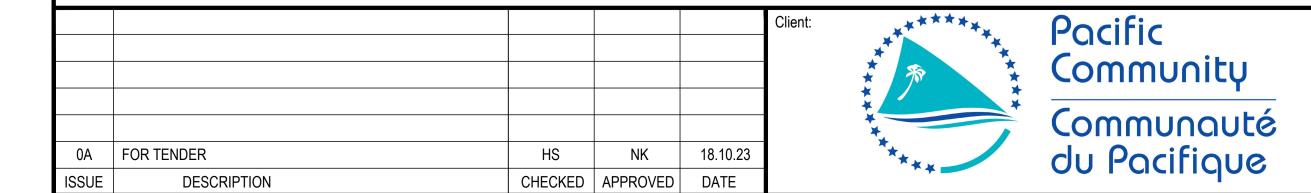



CIVIL,STRUCTURAL & PROJECT MANAGEMENT			
RATU MARA ROAD, SUVA	TELEPHONE: (679) 3313388		
O.Box 1208	MOBILE: (679)		
JVA	FAX: (679) 3302903		
JI	EMAIL: infor@nrwmacallan.com.f		

Drafter: HT	Designed:	PROJECT:  MANAGING COASTAL AQUIFERS (MCAP), WOTJE, MARSHALL ISLAND
Checked: HS/NK	Date: 23.08.23	COMMUNITY FILLING POINT SITE PLAN
Scale A1: AS SHOWN	Scale A3: HALF SHOWN	TYPICAL SECTIONS

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1. ALL DIMENSION ARE IN MILLIMETERS UMLESS NOTED

OTHERWISE. 2. PIPE AND STRUCTURE LEVELS TO BE CONFIRN=MED

ON SITE BY THE ENGINEER. 3. BEFORE CONSTRUCTION, CONTRACTOR TO RE-CHECK

EXISTING DIMENSION ONSITE. 4. CONTRACTOR TO SEEK DESIGNER APPROVAL IF

CHANGES ARE MADE TO THE DRAWINGS. 5. ALL PIPE CONNECTION IS TO BE CONFIRMED BY THE ENGINEER PRIOR TO PROCUREMENT.

6. ANT OTHER CHANGES MADE APART FROM THE DISIGNERS APPROVAL, CLIENT WILL BARE EXTRA

